



DEPARTMENT OF PERMITTING, ENVIRONMENT, AND REGULATORY  
AFFAIRS (PERA)  
BOARD AND CODE ADMINISTRATION DIVISION

MIAMI-DADE COUNTY  
PRODUCT CONTROL SECTION

11805 SW 26 Street, Room 208

Miami, Florida 33175-2474  
T (786) 315-2590 F (786) 315-2599

[www.miamidade.gov/building](http://www.miamidade.gov/building)

## NOTICE OF ACCEPTANCE (NOA)

Miami-Dade County Transit Department  
701 NW 1<sup>st</sup> Court, Suite 1700  
Miami, Florida 33136-3922

### SCOPE:

This NOA is being issued under the applicable rules and regulations governing the use of construction materials. The documentation submitted has been reviewed and accepted by Miami-Dade County PERA-Product Control Section to be used in Miami Dade County and other areas where allowed by the Authority Having Jurisdiction (AHJ).

This NOA shall not be valid after the expiration date stated below. The Miami-Dade County Product Control Section (In Miami Dade County) and/or the AHJ (in areas other than Miami Dade County) reserve the right to have this product or material tested for quality assurance purposes. If this product or material fails to perform in the accepted manner, the manufacturer will incur the expense of such testing and the AHJ may immediately revoke, modify, or suspend the use of such product or material within their jurisdiction. PERA reserves the right to revoke this acceptance, if it is determined by Miami-Dade County Product Control Section that this product or material fails to meet the requirements of the applicable building code.

This product is approved as described herein, and has been designed to comply with the High Velocity Hurricane Zone of the Florida Building Code.

**DESCRIPTION:** Miami Bus Shelter Slim Version W/O Oppi Pal-Li Solar Display Panel

**APPROVAL DOCUMENT:** Drawing No. 12-033, titled "Miami Bus Shelter Slim Version W/O Oppi Pal-Li Solar Display Panel", sheets 1 through 15 of 15, prepared by Tilteco, Inc., dated February 10, 2012, signed and sealed by Walter A. Tillit Jr., P.E., on February 21, 2012, bearing Miami-Dade County Product Control Revision stamp with the Notice of Acceptance number & expiration date by Miami-Dade County Product Control Section.

**MISSILE IMPACT RATING:** None

**LABELING:** Each bus shelter shall bear a permanent label with the manufacturer's name or logo, city, state and the following statement: "Miami-Dade County Product Control Approved", unless otherwise noted herein.

**RENEWAL** of this NOA shall be considered after a renewal application has been filed and there has been no change in the applicable building code negatively affecting the performance of this product.

**TERMINATION** of this NOA will occur after the expiration date or if there has been a revision or change in the materials, use, and/or manufacture of the product or process. Misuse of this NOA as an endorsement of any product, for sales, advertising or any other purposes shall automatically terminate this NOA. Failure to comply with any section of this NOA shall be cause for termination and removal of NOA.

**ADVERTISEMENT:** The NOA number preceded by the words Miami-Dade County, Florida, and followed by the expiration date may be displayed in advertising literature. If any portion of the NOA is displayed, then it shall be done in its entirety.

**INSPECTION:** A copy of this entire NOA shall be provided to the user by the manufacturer or its distributors and shall be available for inspection at the job site at the request of the Building Official. This approval is limited to only the Structural Adequacy of the Bus Shelter and the display unit. All others are not part of this Approval. This NOA revises NOA # 08-0804.06 and consists of this page 1, the evidence submitted pages E-1 & E-2 as well as approval document mentioned above.

The submitted documentation was reviewed by Helmy A. Makar, P.E., M.S.



*Helmy A. Makar*  
04/12/2012

NOA No. 12-0227.20  
Expiration Date: 09/11/2013  
Approval Date: 04/12/2012  
Page 1

**Miami-Dade County Transit Department**

**NOTICE OF ACCEPTANCE: EVIDENCE SUBMITTED**

**1. EVIDENCE SUBMITTED UNDER PREVIOUS APPROVAL # 08-0804.06**

**A. DRAWINGS:**

1. *Drawing No. 07-229, titled " Miami Bus Shelter Slim Version W/O Oppi Pal-Li Solar Display Panel", sheets 1 through 15 of 15, prepared by Tilteco, Inc., dated 09/13/2007, last revision #2 dated 04/02/2008, signed and sealed by Walter A. Tillit Jr., P.E.*

**B. TESTS:**


1. *Test report on Uniform Static Air Pressure Test, TAS 202, of bus shelter roof panel, prepared by Fenestration Testing Laboratory, Inc., Report No. 3867, dated September 4, 2003, signed and sealed by Joseph Chan, P.E.*
2. *Test report on Uniform Static Air Pressure Test, TAS 202, of bus shelter solar roof panel, prepared by Fenestration Testing Laboratory, Inc., Report No. 3795, dated July 3, 2003, signed and sealed by Joseph Chan, P.E.*
3. *Test report on Uniform Static Air Pressure Test, TAS 202, of bus shelter rear panel back section, prepared by Fenestration Testing Laboratory, Inc., Report No. 3891, dated September 4, 2003, signed and sealed by Joseph Chan, P.E.*
4. *Test report on Uniform Static Air Pressure Test, TAS 202, of bus shelter roof panel, prepared by Fenestration Testing Laboratory, Inc., Report No. 3901, dated September 4, 2003, signed and sealed by Joseph Chan, P.E.*
5. *Test report on Uniform Static Air Pressure Test, TAS 202, of bus shelter solar display panel, prepared by Fenestration Testing Laboratory, Inc., Report No. 3792, dated September 4, 2003, signed and sealed by Joseph Chan, P.E.*
6. *Test report on Uniform Static Air Pressure Test, TAS 202, of bus shelter solar display panel, prepared by Fenestration Testing Laboratory, Inc., Report No. 3788, dated September 4, 2003, signed and sealed by Joseph Chan, P.E.*
7. *Test report on Gravity Load Test, of bus shelter Steel Rolled form Bench, prepared by Fenestration Testing Laboratory, Inc., Report No. 3920, dated September 3, 2003, signed and sealed by Joseph Chan, P.E.*

**C. CALCULATIONS:**

1. *Miami Bus Shelter Slim Version W/O Oppi Pal-Li Solar Display Panel design and anchor analysis dated August 01, 2008, Pages 1 through 34 of 34, prepared by Tilteco, Inc., signed and sealed by Walter A. Tillit Jr., P.E.*

**D. QUALITY ASSURANCE:**

1. *By Miami-Dade County Building Code Compliance Office.*
2. *Tensile Test Report No. 3926, prepared by Fenestration Testing Laboratory, Inc.*

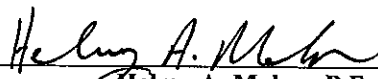

**Helmy A. Makar, P.E., M.S.  
PERA, Product Control Unit Supervisor**

**NOA No. 12-0227.20**

**Expiration Date: 09/11/2013**

**Approval Date: 04/12/2012**

**Miami-Dade County Transit Department**

**NOTICE OF ACCEPTANCE: EVIDENCE SUBMITTED**

**E. MATERIAL CERTIFICATION:**

1. *Mill Certified Test Report issued by Amerimet Corporation, dated 07/16/03 with chemical composition and mechanical properties of aluminum alloy 3003-H154.*

**1. NEW EVIDENCE SUBMITTED**

**A. DRAWINGS:**

1. *Drawing No. 12-033, titled "Miami Bus Shelter Slim Version W/O Oppi Pal-Li Solar Display Panel", sheets 1 through 15 of 15, prepared by Tilteco, Inc., dated February 10, 2012, signed and sealed by Walter A. Tillit Jr., P.E., on February 21, 2012.*

**B. TESTS:**

1. *None.*

**C. CALCULATIONS:**


1. *Miami Bus Shelter Slim Version W/O Oppi Pal-Li Solar Display Panel design dated February 21, 2012, Pages 1 through 9 of 9, prepared by Tilteco, Inc., signed and sealed by Walter A. Tillit Jr., P.E.*

**D. QUALITY ASSURANCE:**

1. *By Miami-Dade County Department of Permitting, Environment, and Regulatory Affairs (PERA).*

**E. MATERIAL CERTIFICATION:**

1. *None.*

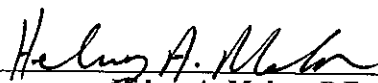

Helmy A. Makar, P.E., M.S.  
PERA, Product Control Unit Supervisor  
NOA No. 12-0227.20  
Expiration Date: 09/11/2013  
Approval Date: 04/12/2012

# MIAMI BUS SHELTER SLIM VERSION W/O OPPI PAL-LI SOLAR DISPLAY PANEL

## GENERAL NOTES:


### (I) MIAMI BUS SHELTER SLIM VERSION W/O OPPI PAL-LI SOLAR DISPLAY PANEL

- 1.- MIAMI BUS SHELTER SLIM VERSION SHOWN ON THIS PRODUCT APPROVAL DOCUMENT (P.A.D.) HAS BEEN VERIFIED FOR CODE COMPLIANCE USING INFORMATION FROM A CURRENT MIAMI-DADE COUNTY NOA, WHICH CORRESPONDING TO A LARGE SHELTER SIZE IN ACCORDANCE WITH THE 2007 & 2010 EDITIONS OF THE FLORIDA BUILDING CODE.  
DESIGN WIND LOADS HAVE BEEN DETERMINED IN ACCORDANCE WITH SECTION 1820 OF THE ABOVE MENTIONED CODES, FOR A BASIC WIND SPEED OF 145 M.P.H. (F.B.C. 2007) & 175 M.P.H. (F.B.C. 2010) AND IN ACCORDANCE WITH ASCE 7-05 & ASCE 7-10 STANDARDS, RESPECTIVELY.  
TESTING FOR WIND CAPACITY HAS BEEN PERFORMED IN ACCORDANCE OF TAS-202 AND AS PER ASTM E-330 STANDARD, PER FENESTRATION TESTING LAB REPORTS # 3867, 3785, 3891, 3901 AND 3925. THIS STRUCTURE SHALL ONLY BE INSTALLED WHERE A.S.D. DESIGN WIND LOADS DO NOT EXCEED THE MAXIMUM VALUES INDICATED BELOW.  
MAXIMUM A.S.D. DESIGN LOADS ARE:  
DEAD LOADS ON STRUCTURAL ROOF: 5.0 P.S.F.  
LIVE LOADS ON STRUCTURAL ROOF: 30 P.S.F.  
MAX. A.S.D. DESIGN PRESSURE RATING FOR WIND:  
- ON STRUCTURAL ROOF: +50, -80 P.S.F. (S.F.=2.00)  
- ON REAR GLASS WALL: +50, -81 P.S.F. (S.F.=1.50)
- 2.- ALL STEEL POSTS AND PLATES TO BE MADE OF AISI 304 SERIES WITH A MINIMUM YIELD STRENGTH OF 42.0 ksi.
- 3.- ALL ALUMINUM EXTRUSIONS SHALL BE MADE OF A MINIMUM ALUMINUM ASSOCIATION ALLOY AND TEMPER CORRESPONDING TO 6063-T6.
4. ALUMINUM EXTRUSIONS IN CONTACT WITH STEEL SHALL BE PROTECTED APPLYING KOPPERS BITUMINOUS PAINT ACCORDING TO FLORIDA BUILDING CODE SECTION 2003.8.4.2.
5. BENCH MATERIAL SHALL BE ASTM A-1011 HOT ROLLED STEEL, W/ A MINIMUM YIELD STRENGTH OF 40.0 ksi, PAINTED AS PER FEDERAL SPECIFICATIONS CORRESPONDING TO RED OXIDE PAINT OR EQUAL. MATERIAL TO BE COATED WITH DENFLEX PX-12412 PVC PLASTISOL COATING, 0.125" THICK, AS MANUFACTURED BY POLYONE, CHICAGO, ILLINOIS W/ 10.4 Lb/Gallon DENSITY, 2300 psi TENSILE STRENGTH (ASTM D-412), 419 psi TEAR STRENGTH (ASTM D-624).  
COATING WAS EXPOSED FOR 1000 hrs. IN A QUV ULTRAVIOLET CHAMBER, RESULTING ON SOME LOSS OF GLOSS BUT NO PHYSICAL PROPERTY DEGRADATION. COATING SHALL MAINTAIN A COMFORTABLE TEMPERATURE OF BENCH'S SURFACE UNDER EXTREME WEATHER CONDITIONS (HOT OR COLD). THIS ENGINEER IS NOT RESPONSIBLE FOR THE THERMAL PERFORMANCE OF THIS COATING, WHICH SHALL BE GUARANTEED BY THE COATING MANUFACTURER. MAXIMUM BENCH CAPACITY IS 640 Lbs.
- 6.- ALL MACHINE SCREWS & BOLTS TO BE AISI 304 OR 316 SERIES STAINLESS STEEL. MINIMUM SHEAR STRENGTH SHALL BE 80.0 ksi. MINIMUM TENSILE STRENGTH SHALL BE 90.0 ksi. AS PER ASTM A-276 STANDARD. ALL SHEET METAL SCREWS TO BE STAINLESS STEEL 304 OR 316 AISI SERIES OR CORROSION RESISTANT COATED CARBON STEEL AS PER DIN 50018 WITH 50 ksi YIELD POINT AND 90 ksi TENSILE STRENGTH & SHALL COMPLY W/ FLORIDA BUILDING CODE SECTION 2411.3.3.4.
- 7.- ALL RIVETS TO BE STAINLESS STEEL WITH A MINIMUM OF 550 LB. SHEAR STRENGTH AND 700 LB. MINIMUM TENSILE STRENGTH.
- 8.- ALL WELDING OF STAINLESS STEEL MEMBERS SHALL BE PERFORMED IN ACCORDANCE WITH THE AMERICAN WELDING SOCIETY AWS D1.8 REGULATIONS. ELECTRODES SHALL BE MADE OF STAINLESS STEEL WITH A MINIMUM TENSILE STRENGTH OF 80.0 ksi (A.W.S. CLASSIFICATION E-308, E309 OR EQUAL. ALL WELDING OF ALUMINUM MEMBERS TO CONFORM WITH THE AMERICAN WELDING SOCIETY A.W.S. D.1.2 REGULATIONS. USE E-5556 OR 5355 ELECTRODES. USE CERTIFIED WELDERS.
- 9.- STRUCTURAL INSULATED ROOF PANEL IS A 3" THICK 1LB/FT<sup>2</sup> DENSITY EXPANDED POLYSTYRENE AS MANUFACTURED BY DYPLAST PRODUCTS LLC, W/ MIAMI DADE COUNTY PRODUCT APPROVED, WITH 0.035" THICK. (STUCCO EMBOSSED) 3003-H154, ALUMINUM SKIN (W/ A MINIMUM YIELD STRENGTH OF 28.00 ksi) TOP AND BOTTOM AND ADHERED TO POLYSTYRENE TO SKIN WITH MOR-AD M-464 URETHANE PREPOLYMER SOLUTION, PRODUCED BY MORTON INTERNATIONAL, INC. CHICAGO, ILLINOIS 60606-1588.
- 10.- GLASS AT REAR WALL OF BUS SHELTER SHALL BE 10mm THICK, TEMPERED AND SHALL COMPLY WITH SECTION 2411.1.3 OF THE FLORIDA BUILDING CODE.
- 11.- ANCHORS USED TO CONNECT POST'S BASE PLATES TO CONCRETE FOUNDATION SHALL BE EITHER OF THE FOLLOWING TYPES:  
(a.) 5/8" DIAMETER GALVANIZED STEEL ANCHOR BOLTS, WITH STRAIGHT SHAFT, HEAD AND NUT. TO COMPLY WITH ASTM F1554, GALVANIZED TO ASTM A-153 WITH A MINIMUM YIELD STRENGTH OF 36ksi, AND TO PENETRATE A MINIMUM OF 8" IN TO THE EPOXY TO THE CONCRETE FOUNDATION.  
MINIMUM A.S.D. TENSION LOAD CAPACITY: 6200 LB.  
MINIMUM A.S.D. SHEAR LOAD CAPACITY: 3100 LB.  
ANCHORS SHALL BE INSTALLED STRICTLY FOLLOWING THE SPECIFICATIONS OF THE ANCHOR MANUFACTURER AND THE DETAILS SHOWN ON THIS PRODUCT APPROVAL DOCUMENT.
- 12.- ALL CONCRETE TO DEVELOP A 28 DAY MINIMUM COMPRESSIVE STRENGTH f'<sub>c</sub> OF 3000 psi. ALL REBARS TO BE ASTM A-615 DEFORMED BARS. ALL CONCRETE CONSTRUCTION TO COMPLY WITH ACI 318-08 BUILDING CODE REQUIREMENTS FOR STRUCTURAL CONCRETE.
- 13.- REQUIRED FRAMING FOR INSTALLATION OF SHELTER WITHIN EXPOSURES C OR D AS DEFINED BY ASCE 7-10 STANDARD SHALL BE PROVIDED BASED ON SCHEDULE ON SHEET 4 OF 15 OF THIS DRAWING.

### (II) MIAMI BUS SHELTER SLIM VERSION W/O OPPI PAL-LI SOLAR DISPLAY PANEL

- 1.- ALL MECHANICAL DETAILS AND SPECIFICATIONS, AS APPLICABLE, ARE NOT PART OF THIS DRAWING. THEY SHALL BE PREPARED A FLORIDA REGISTERED ENGINEER OR ARCHITECT AND SHALL BE REVIEWED BY THE CORRESPONDING BUILDING DEPARTMENT IN ORDER TO ISSUE A PERMIT FOR CONSTRUCTION.
- 2.- ALL ZONING DETAILS AND SPECIFICATIONS NEEDED FOR THE LOCATION, USE AND CONSTRUCTION OF BUS SHELTER SLIM VERSION IS NOT PART OF THIS DRAWING AND SHALL BE SUBMITTED SEPARATELY TO THE CORRESPONDING ZONING DEPARTMENT IN ORDER TO ISSUE A PERMIT FOR CONSTRUCTION.
- 3.- MINIMUM SOIL BEARING CAPACITY SHALL BE 2000 P.S.F.
- 4.- SHELTER'S DIMENSIONS HAVE BEEN PROVIDED TO THIS OFFICE BY MIAMI DADE COUNTY TRANSIT DEPARTMENT AND THEY NOT HAVE BEEN ESTABLISHED BY THIS OFFICE.
- 5.- (a.) THIS DRAWING PREPARED BY THIS ENGINEER IS GENERIC AND DOES NOT PROVIDE INFORMATION FOR A SITE SPECIFIC PROJECT; I.e. WHERE THE SITE CONDITIONS DEVIATE FROM THE DRAWING.  
(b.) CONTRACTOR TO BE RESPONSIBLE FOR THE SELECTION, PURCHASE AND INSTALLATION INCLUDING LIFE SAFETY OF THIS PRODUCT BASED ON THIS DRAWING PROVIDED HE/SHE DOES NOT DEVIATE FROM THE CONDITIONS DETAILED ON THIS DOCUMENT. CONSTRUCTION SAFETY AT SITE IS THE CONTRACTOR'S RESPONSIBILITY.  
(c.) THIS DRAWING WILL BE CONSIDERED INVALID IF ALTERED BY ANY MEANS.  
(d.) SITE SPECIFIC PROJECTS SHALL BE PREPARED BY A FLORIDA REGISTERED ENGINEER OR ARCHITECT WHICH WILL BECOME THE ENGINEER OF RECORD (E.O.R.) FOR THE PROJECT AND WHO WILL BE RESPONSIBLE FOR THE PROPER USE OF THE DRAWING. ENGINEER OF RECORD, ACTING AS A DELEGATED ENGINEER TO THIS ENGINEER SHALL SUBMIT TO THIS LATTER THE SITE SPECIFIC DRAWINGS FOR REVIEW.  
(e.) THIS DRAWING SHALL BEAR THE DATE AND ORIGINAL SEAL AND SIGNATURE OF THE PROFESSIONAL ENGINEER OF RECORD THAT PREPARED IT.
- 6.- FINISH COLOR FOR BUS SHELTER SLIM VERSION IS NOT PART OF THIS DRAWING, BUT SHALL BE DEFINED AS PER AGREEMENT BETWEEN MANUFACTURER AND OWNER OF BUS SHELTER.
7. THIS DRAWING IS A GENERIC STRUCTURAL DRAWING AND DOES NOT CONSTITUTE AT ALL A SHOP DRAWING FOR THE DIRECT MANUFACTURING OF THIS BUS SHELTER.
8. LABELING OF THIS PRODUCT SHALL COMPLY W/ THE 2007 & 2010 EDITIONS OF THE FLORIDA BUILDING CODE.

PRODUCT REVISED  
as complying with the Florida  
Building Code  
Acceptance No/2-0227.20  
Expiration Date 09/11/2013  
By *Walter A. Tillit Jr.*  
Miami Dade Product Control  
MIAMI DADE COUNTY

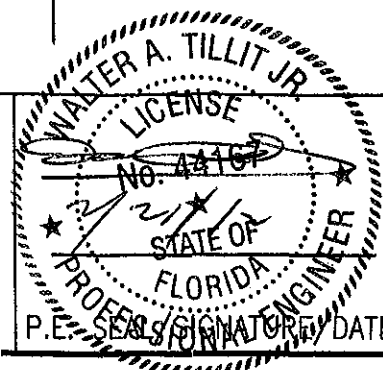

**TILTECO INC.**  
TILLIT TESTING & ENGINEERING COMPANY  
6355 N.W. 38th St., Ste. 305,  
VIRGINIA GARDENS, FL 33166  
Phone: (305) 871-1630. Fax: (305) 871-1631  
e-mail: tilliteco@aol.com  
ES-0006719  
WALTER A. TILLIT Jr., P. E.  
FLORIDA Lic. # 44167

MIAMI BUS  
SHELTER  
SLIM VERSION  
W/O OPPI PAL-LI  
SOLAR DISPLAY  
PANEL

GENERAL NOTES

MIAMI-DADE COUNTY TRANSIT  
DEPARTMENT  
701 NW 1ST COURT, SUITE 1700  
MIAMI, FLORIDA 33138-3922


DRAWN BY:  
M.C.V./A.G.

02/10/12


DATE:

12-033  
DRAWING No.


SHEET 1 OF 16

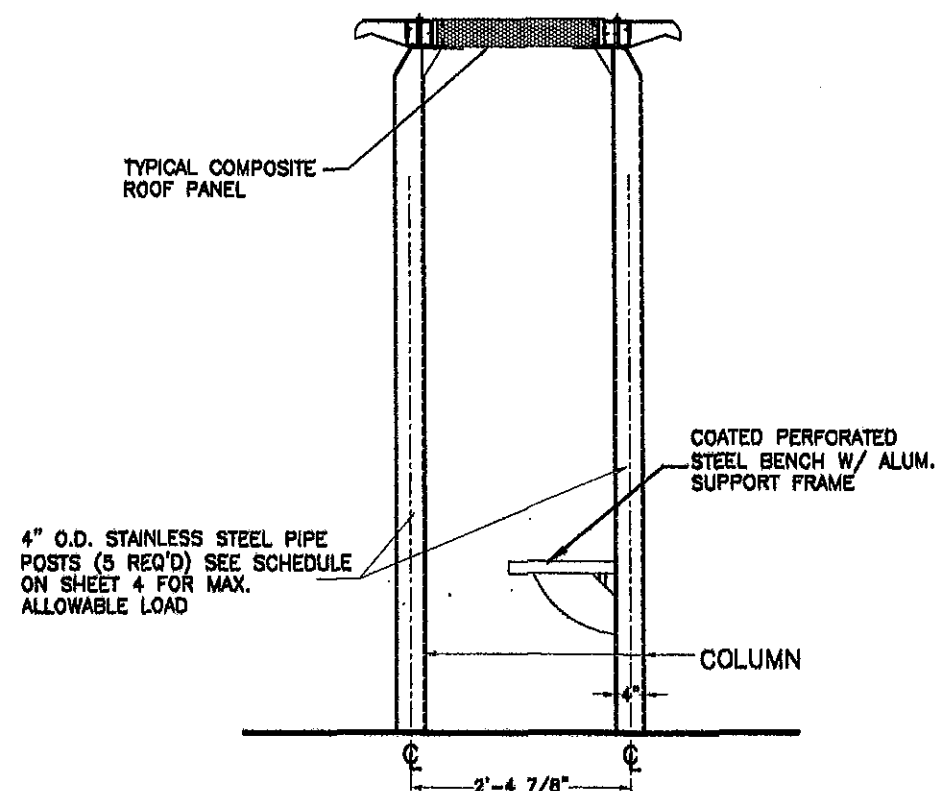


**RIGHT SIDE ELEVATION**  
SCALE: 1/2"=1'-0"

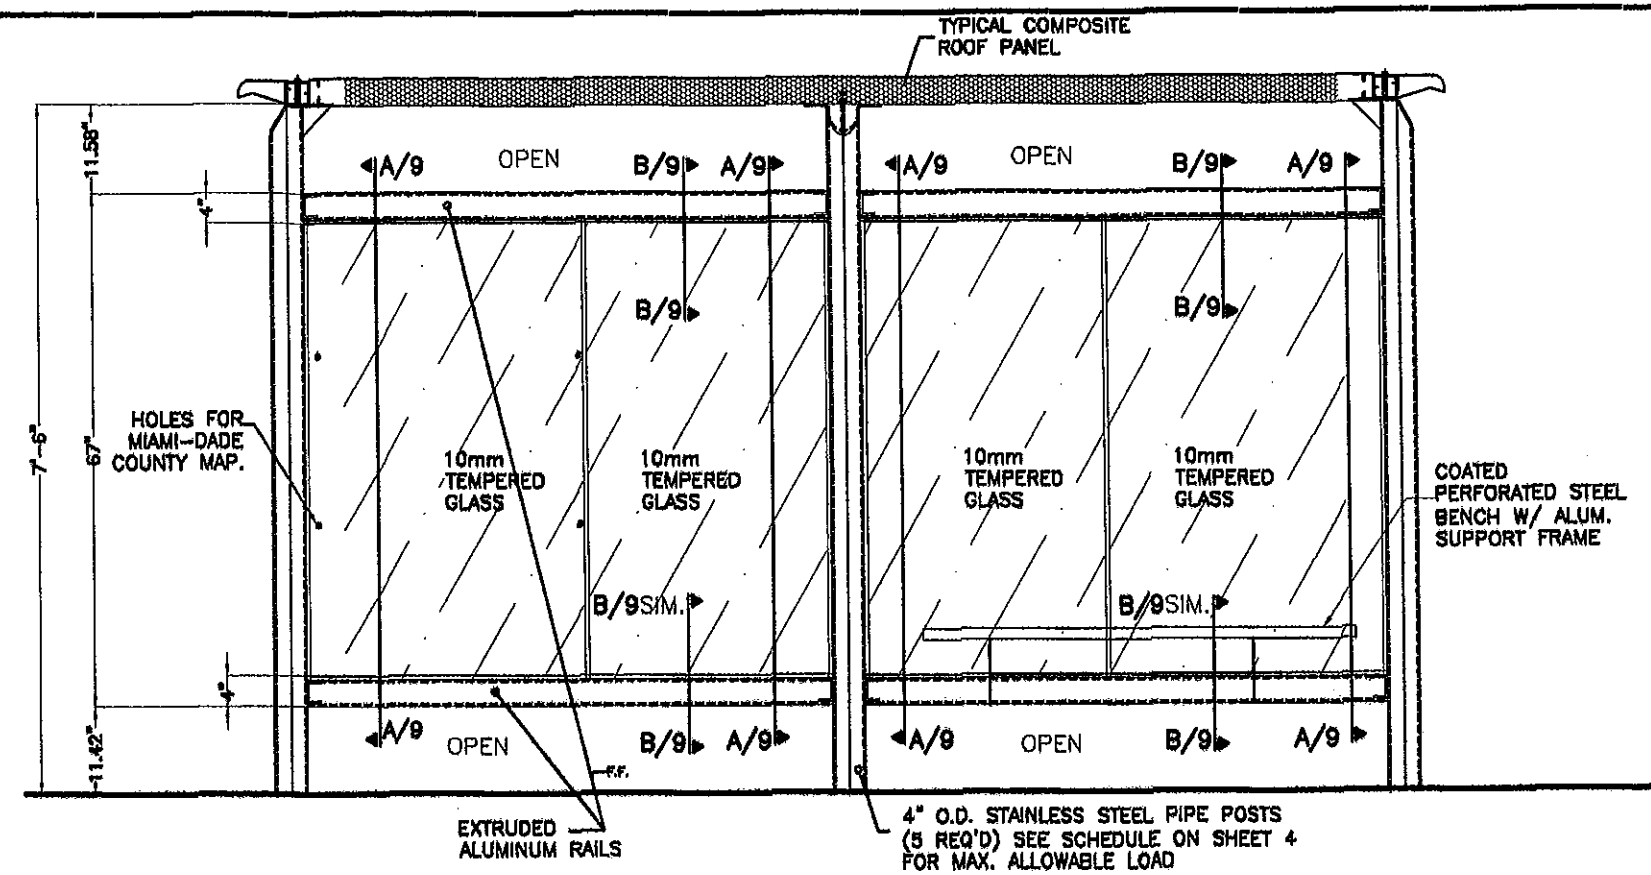

**REAR WALL ELEVATION**  
SCALE: 1/2"=1'-0"

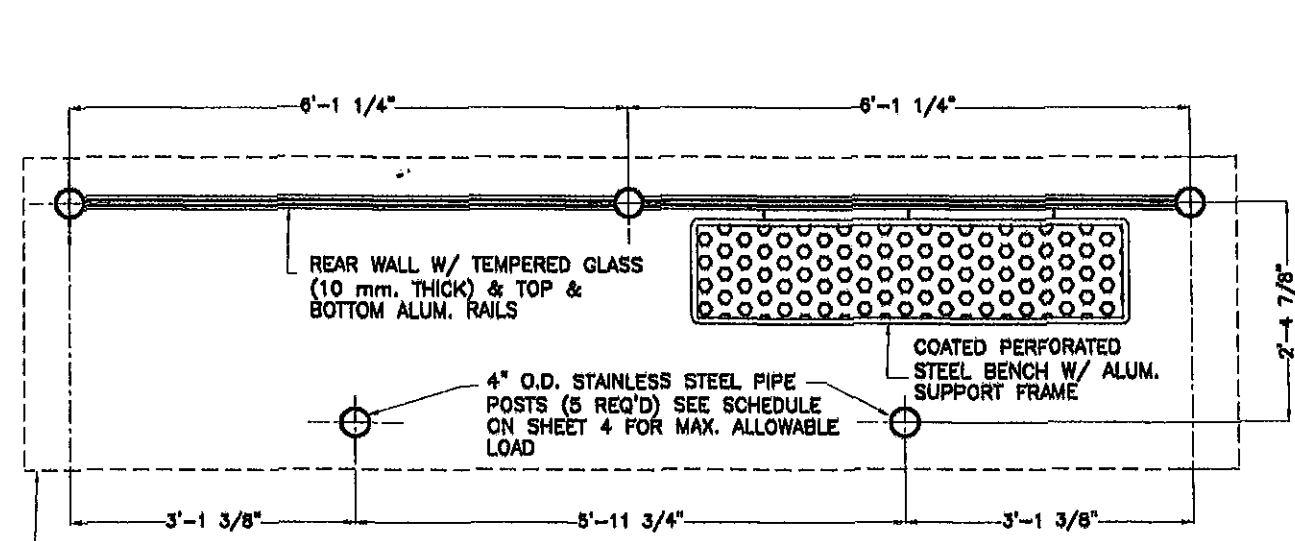


**FLOOR PLAN**  
SCALE: 1/2"=1'-0"

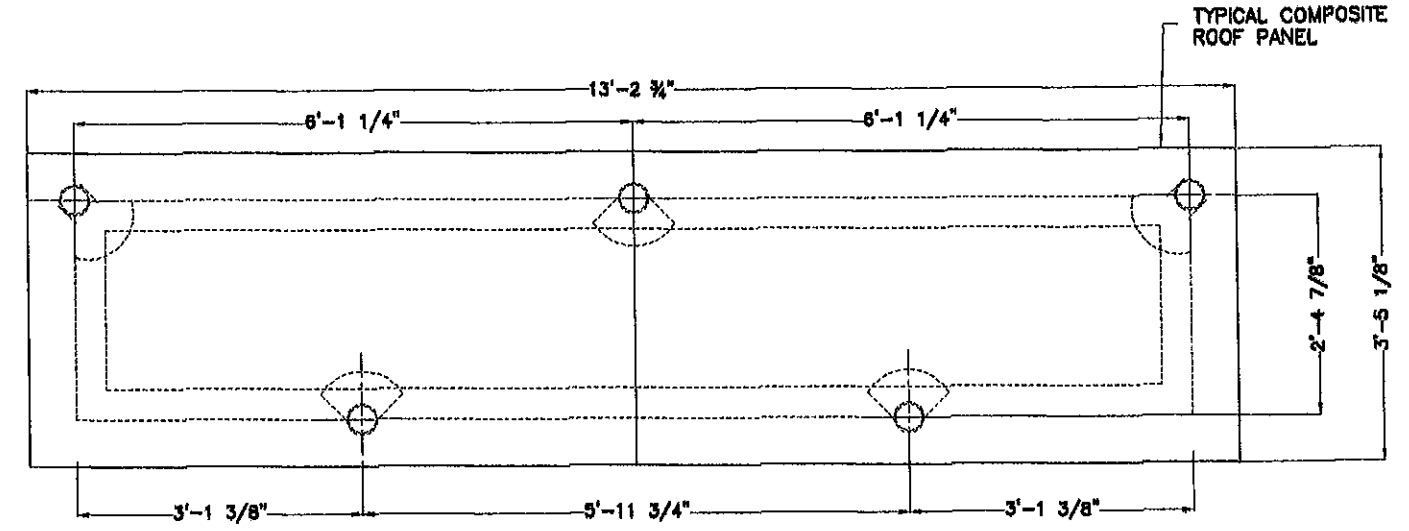



**ROOF PLAN**  
SCALE: 1/2"=1'-0"

|  |  |  |   |   |  |
|--|--|--|---|---|--|
| PRODUCT REVISED<br>as complying with the Florida<br>Building Code<br>Acceptance No 12-0227-20<br>Expiration Date 09/11/2018<br>By <i>Walter A. Tillit Jr.</i><br>Miami Dade Product Control<br>MIAMI DADE COUNTY | WALTER A. TILLIT JR.<br>LICENSE NO. 44167<br>STATE OF FLORIDA<br>PROFESSIONAL ENGINEER<br>P.E. SEAL SIGNATURE/DATE | <b>TILTECO INC.</b><br>TILLIT TESTING & ENGINEERING COMPANY<br>8385 N.W. 36th St., Ste. 305,<br>VIRGINIA GARDENS, FL 33186<br>Phone: (305) 871-1530. Fax: (305) 871-1531<br>e-mail: tilteco@aol.com<br>EB-0000719<br>WALTER A. TILLIT Jr., P. E.<br>FLORIDA Lic. # 44167 | <b>MIAMI BUS SHELTER SLIM VERSION W/O OPPI PAL-LI SOLAR DISPLAY PANEL</b> | MIAMI-DADE COUNTY TRANSIT DEPARTMENT<br>701 NW 18T COURT, SUITE 1700<br>MIAMI, FLORIDA 33138-3822 | DRAWN BY:<br>M.C.V./A.G.<br>02/10/12<br>DATE:<br><b>12-033</b><br>DRAWING No.<br>SHEET 2 OF 15 |
|  |  |  |   | PLANS & ELEVATIONS<br>No. 1 Date: Description: Revisions:   |  |

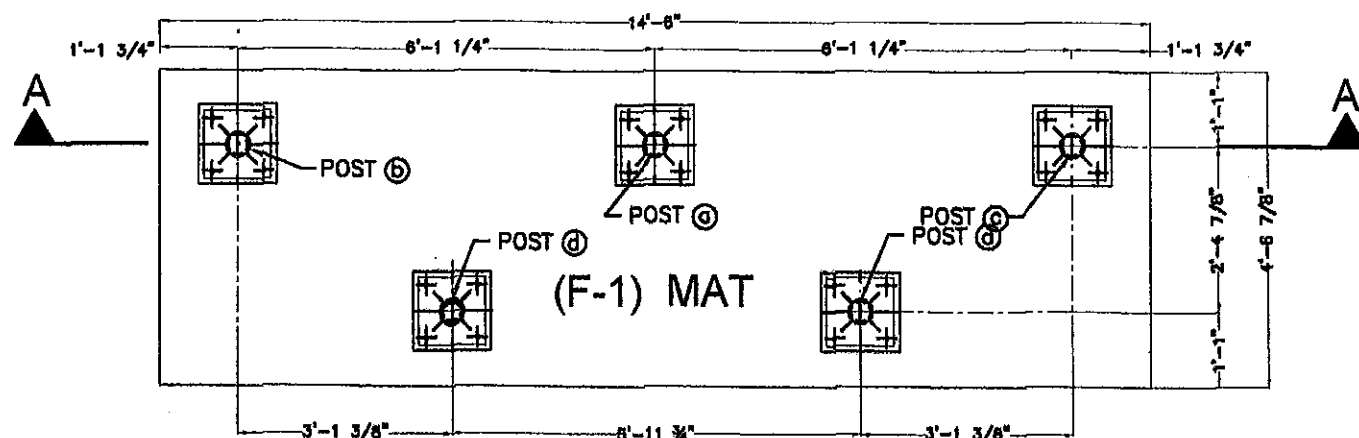

**MAT FOUNDATION PLAN BUS SHELTER**

(f'c = 3ksi CONCRETE)  
SCALE: 3/8" = 1'-0"

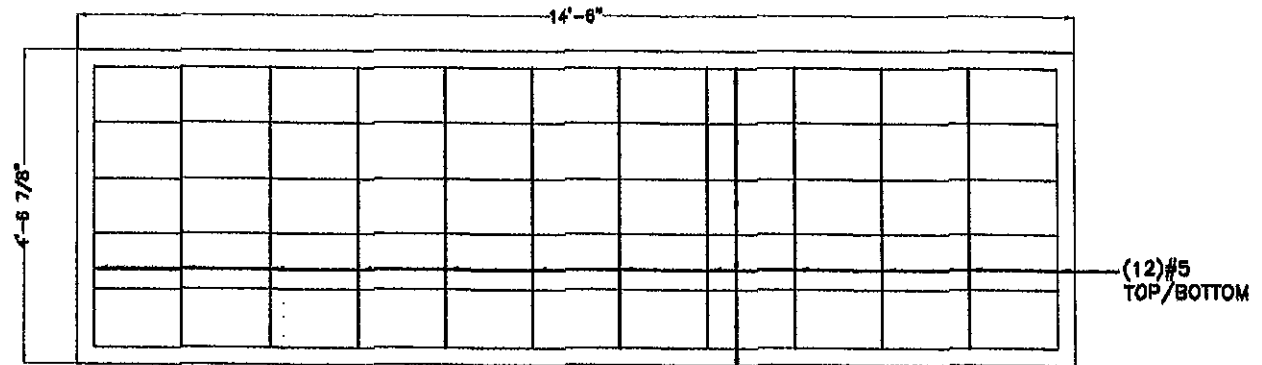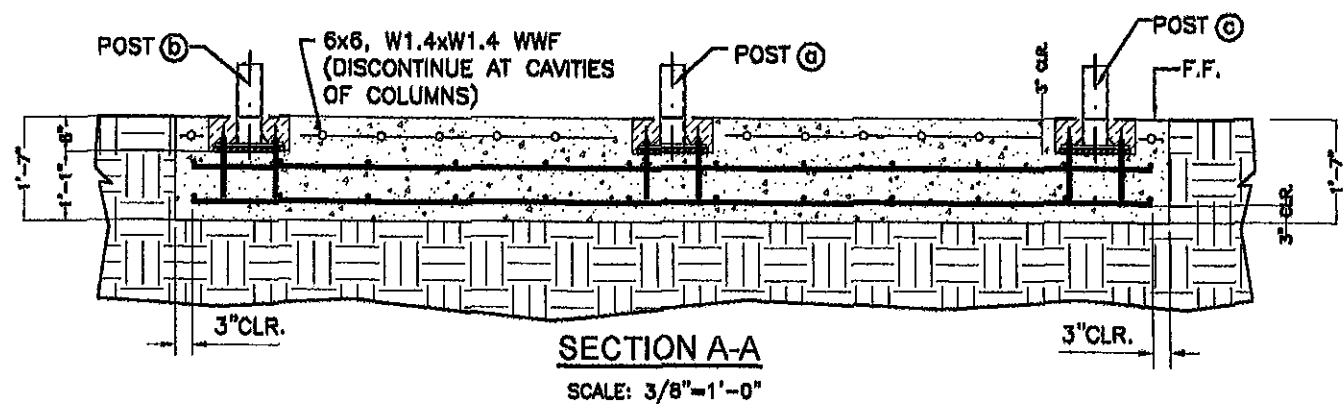


**DETAIL 1**  
TOP / BOTTOM REINFORCEMENT  
FOR 19" THICK CONCRETE MAT.  
(TOP WWF NOT SHOWN FOR CLARITY)

**FOUNDATION NOTES:**


- 1.-THE ELEVATION OF CAVITIES LEFT FOR POST'S BASE PLATES (SEE DETAILS) SHALL BE A MINIMUM OF 6" BELOW THE TOP OF THE BUS SHELTER FINISHED FLOOR SLAB.
- 2.-REINFORCEMENT STEEL SHOULD BE AS INDICATED ON FOOTING SCHEDULE:
- 3.-SEE GENERAL NOTES ON SHEET 1 OF 15 FOR ADDITIONAL SPECIFICATIONS & NOTES.
- 4.-SEE SHEETS 6, 7 & 8 FOR POST/BASE, PLATE SPECIFICATIONS FOR BUS SHELTER.

| FOOTING SCHEDULE |                  |       |  |
|------------------|------------------|-------|--|
| NUMBER           | DIMENSION (WxL)  | DEPTH | STEEL REINFORCEMENT  |
| F-1              | 4'-6 7/8"x14'-8" | 1'-7" | (12) #5 @ 16" MAX. O.C. @ 14'-8" DIRECTION, TOP / BOTTOM.<br>& (6) #5 @ 11" MAX. O.C. 4'-6 7/8" DIRECTION, TOP / BOTTOM. |

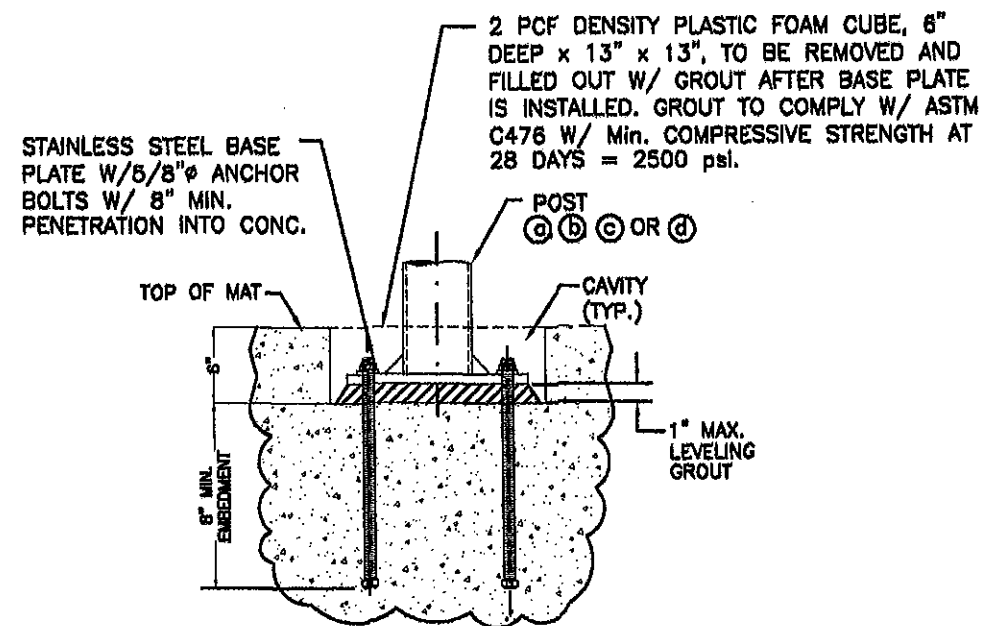

**TYPICAL POST CONNECTION**







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By *Walter A. Tillit Jr.*  
Miami Dade Product Control  
MIAMI DADE COUNTY

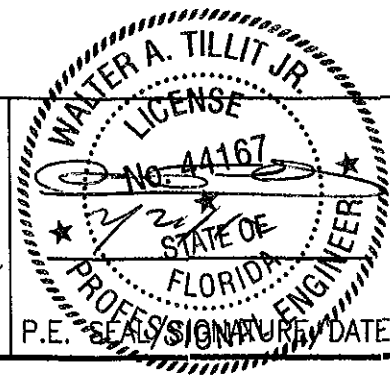

**TILTECO INC.**  
TILLIT TESTING & ENGINEERING COMPANY  
6355 N.W. 38th. St., Ste. 305,  
VIRGINIA GARDENS, FL 33166  
Phone: (305) 871-1530, Fax: (305) 871-1531  
e-mail: tilteco@aol.com  
EB-0008719  
WALTER A. TILLIT Jr., P. E.  
FLORIDA Lic. # 44167

|   |  |              |                          |
|---|--|--------------|--------------------------|
| <b>MIAMI BUS<br/>SHELTER<br/>SLIM VERSION<br/>W/O OPPI PAL-LI<br/>SOLAR DISPLAY<br/>PANEL</b> | <b>MIAMI-DADE COUNTY TRANSIT<br/>DEPARTMENT</b><br><br>701 NW 18T COURT, SUITE 1700<br>MIAMI, FLORIDA 33136-3922 |              | DRAWN BY:<br>M.C.V./A.G. |
|   |  |              | 02/10/12                 |
| <b>FOUNDATION PLAN<br/>&amp; SCHEDULE</b>   |  |              | DATE:                    |
|   |  |              | <b>12-033</b>            |
|   |  |              | DRAWING No.              |
|   | No. Date:  | Description: | <b>SHEET 3 OF 15</b>     |
|   |  | Revisions    |                          |

**SHEET 4 OF 15**

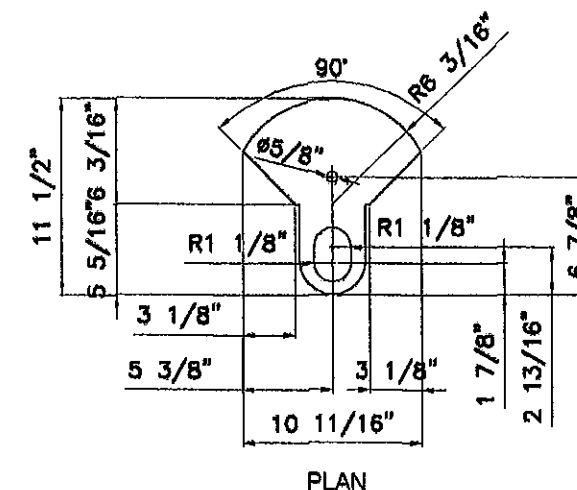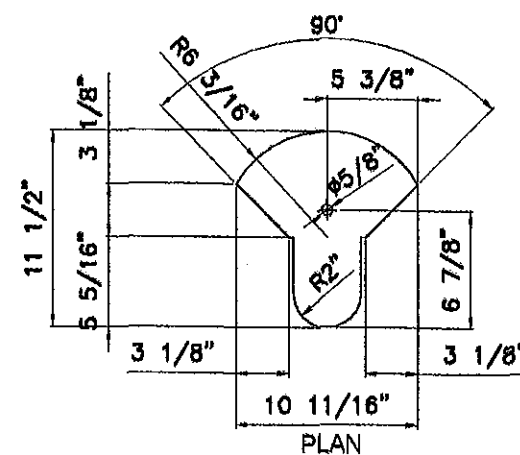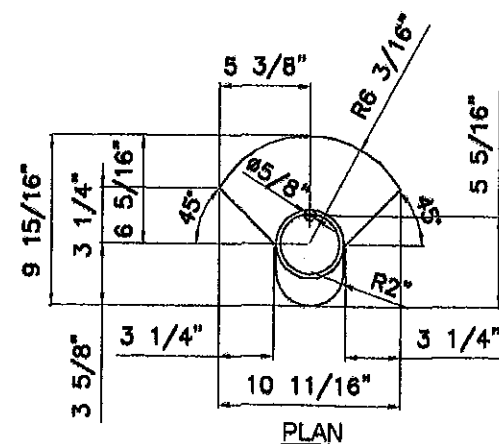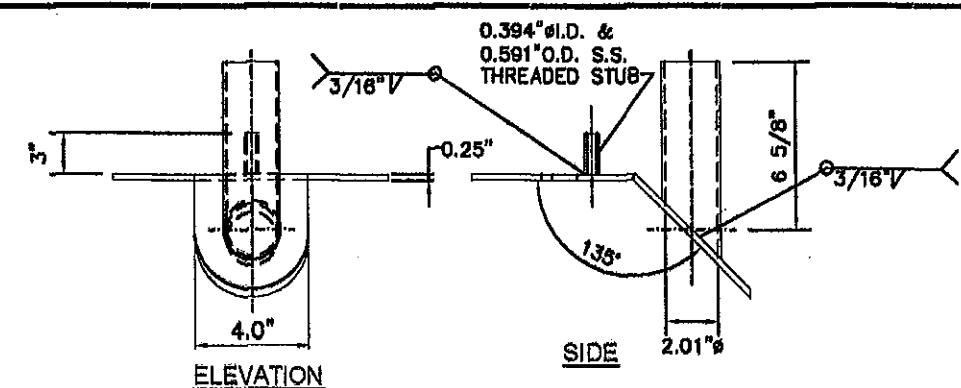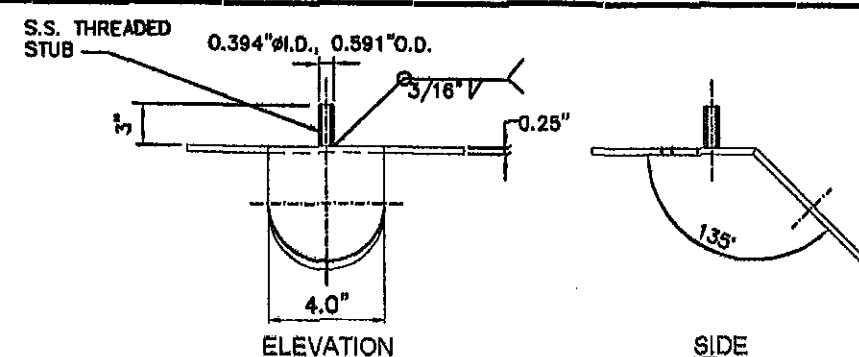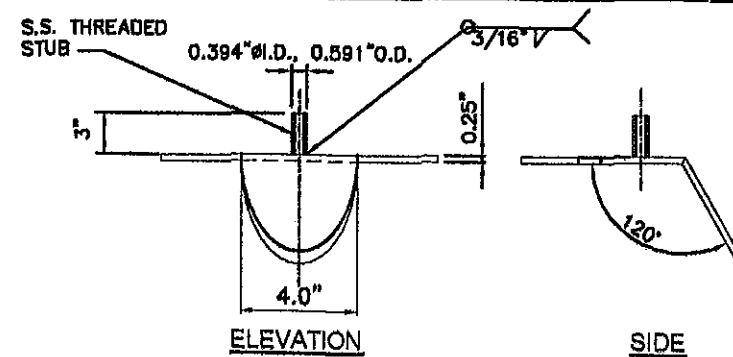

### ③ POST CAP PLATE TYPE A





VALID FOR POSTS (g) & (d)  
REQUIRES:(3) PER UNIT  
MATERIAL: STAINLESS STEEL, AISI 304  
N.T.S.

### ④ POST CAP PLATE TYPE B

VALID FOR POSTS (g)  
REQUIRES:(1) PER UNIT  
MATERIAL: STAINLESS STEEL, AISI 304  
N.T.S.

### ⑤ POST CAP PLATE TYPE C

VALID FOR POSTS (b)  
REQUIRES:(1) PER UNIT  
MATERIAL: STAINLESS STEEL, AISI 304  
N.T.S.

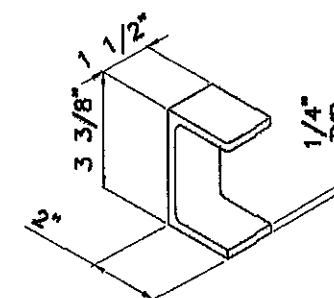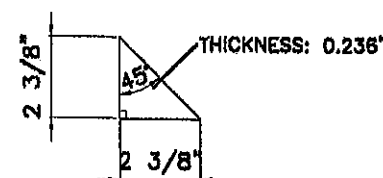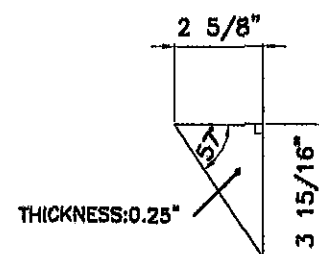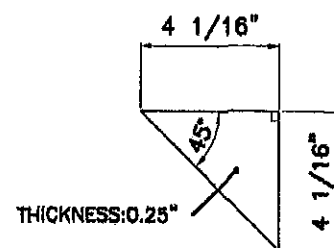

### ⑥ POST CAP PLATE GUSSET

VALID FOR POSTS (b) & (c)  
REQUIRES:(2) PER UNIT  
MATERIAL: STAINLESS STEEL, AISI 304  
N.T.S.

### ⑦ POST CAP PLATE GUSSET

VALID FOR POSTS (g) & (d)  
REQUIRES:(3) PER UNIT  
MATERIAL: STAINLESS STEEL, AISI 304  
N.T.S.

### ⑧ POST BASE PLATE GUSSET


REQUIRES:(20) PER UNIT  
MATERIAL: STAINLESS STEEL, AISI 304  
N.T.S.

### ⑨ POST BRACKET FOR REAR WALL

REQUIRES:(2) PER POST  
MATERIAL: STAINLESS STEEL, AISI 304  
N.T.S.

## BUS SHELTER POST COMPONENTS

PRODUCT REVISED  
as complying with the Florida  
Building Code  
Acceptance No 12-0227.20  
Expiration Date 09/11/2013  
By: *Walter A. Tillit Jr.*  
Miami Dade Product Control  
MIAMI DADE COUNTY

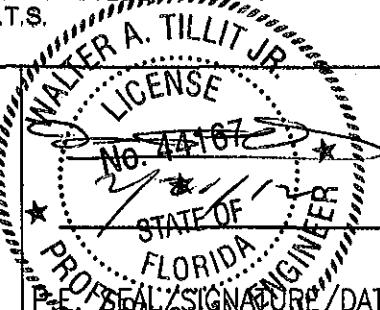

**TILTECO INC.**  
TILLIT TESTING & ENGINEERING COMPANY  
6355 N.W. 38th St., Ste. 305,  
VIRGINIA GARDENS, FL 33166  
Phone: (305) 871-1630, Fax: (305) 871-1631  
e-mail: tiltco@aol.com  
EB-0008719  
WALTER A. TILLIT JR., P.E.  
FLORIDA Lic. # 44167

MIAMI BUS  
SHELTER  
SLIM VERSION  
W/O OPPI PAL-LI  
SOLAR DISPLAY  
PANEL

MIAMI-DADE COUNTY TRANSIT  
DEPARTMENT  
701 NW 18th COURT, SUITE 1700  
MIAMI, FLORIDA 33136-3922

DRAWN BY:  
M.C.V./A.G.







02/10/12

DATE:


12-033  
DRAWING No.

SHEET 5 OF 15




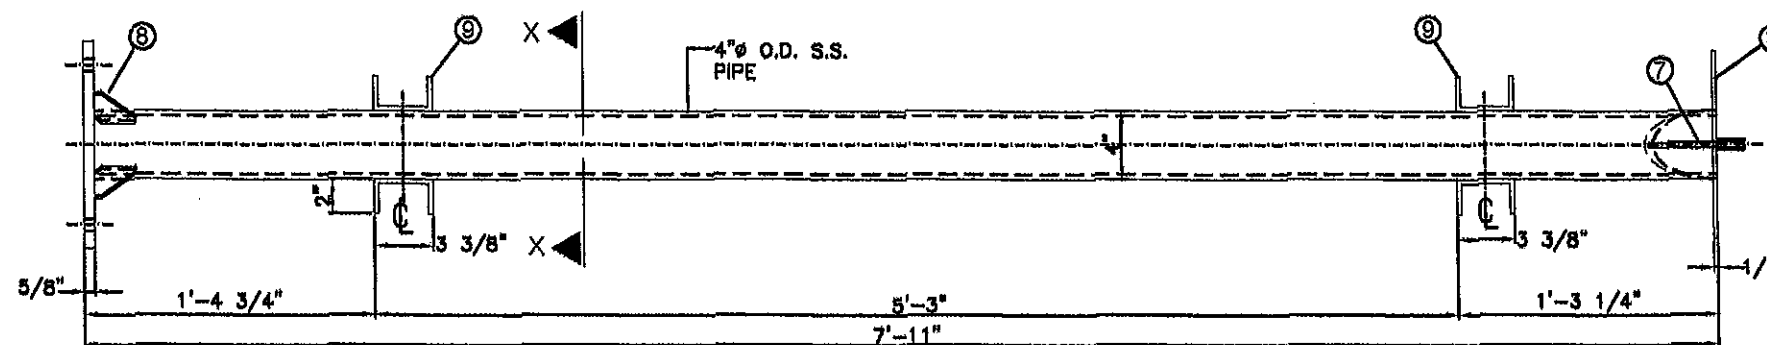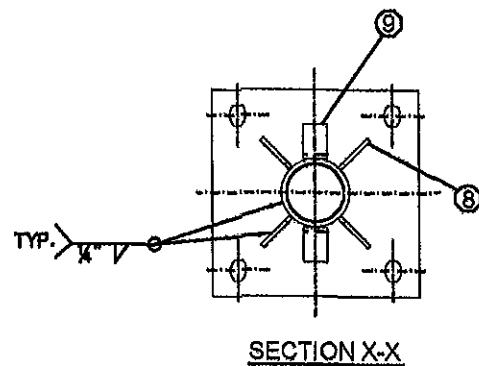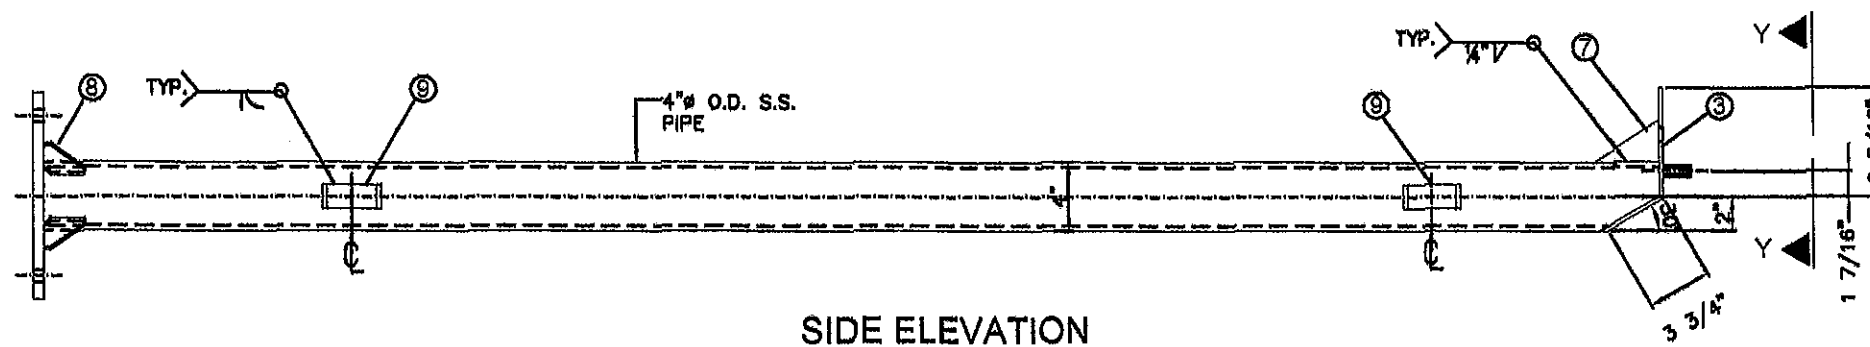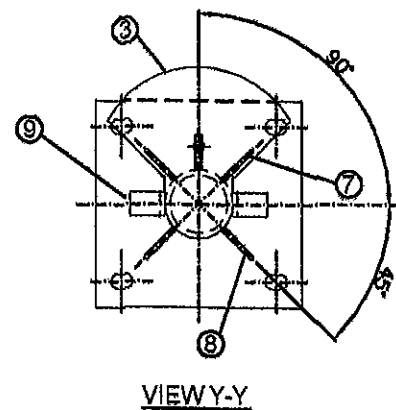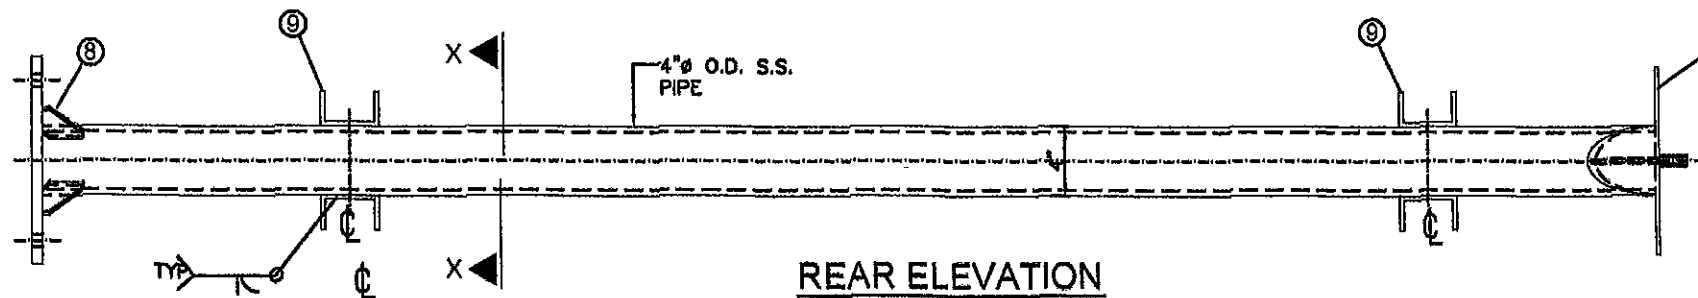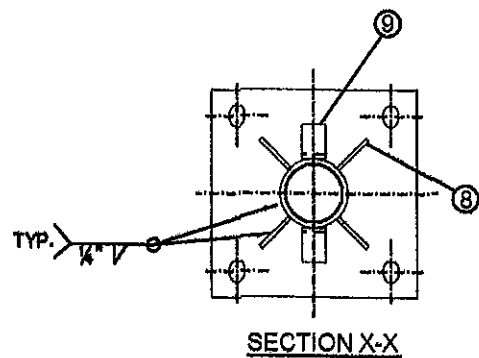

**a REAR CENTER POST**  
 SCALE: 1.15" = 1'-0"  
 REQUIRES: (1) PER UNIT

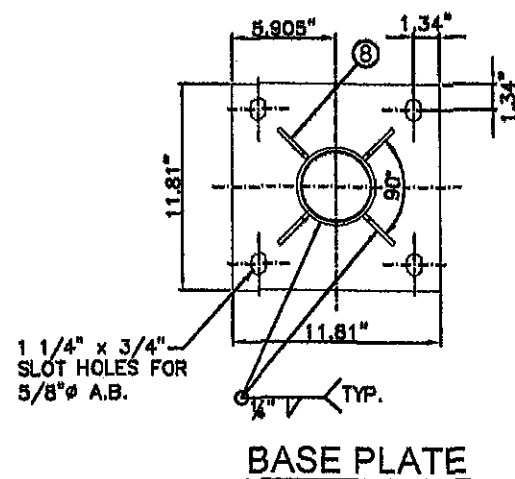

PRODUCT REVISED  
 as complying with the Florida  
 Building Code  
 Acceptance No 12-0227.20  
 Expiration Date 09/11/2013  
 By *Walter A. Tillit Jr.*  
 Miami Dade Product Control  
 MIAMI DADE COUNTY

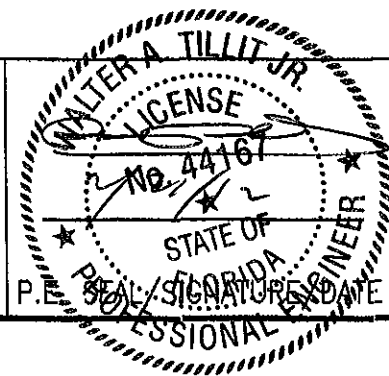







**TILTECO INC.**  
 TILLIT TESTING & ENGINEERING COMPANY  
 8355 N.W. 36th St., Ste. 305,  
 VIRGINIA GARDENS, FL 33186  
 Phone: (305) 871-1630. Fax: (305) 871-1631  
 e-mail: tilteco@aol.com  
 EB-0008719  
 WALTER A. TILLIT Jr., P. E.  
 FLORIDA Lic. # 44167

**MIAMI BUS  
 SHELTER  
 SLIM VERSION  
 W/O OPPI PAL-LI  
 SOLAR DISPLAY  
 PANEL**

POST ELEVATIONS

MIAMI-DADE COUNTY TRANSIT  
 DEPARTMENT  
 701 NW 1ST COURT, SUITE 1700  
 MIAMI, FLORIDA 33136-3922

DRAWN BY:  
 M.C.V./A.G.  
 02/10/12  
 DATE:  
**12-033**  
 DRAWING No.  
 SHEET 6 OF 16

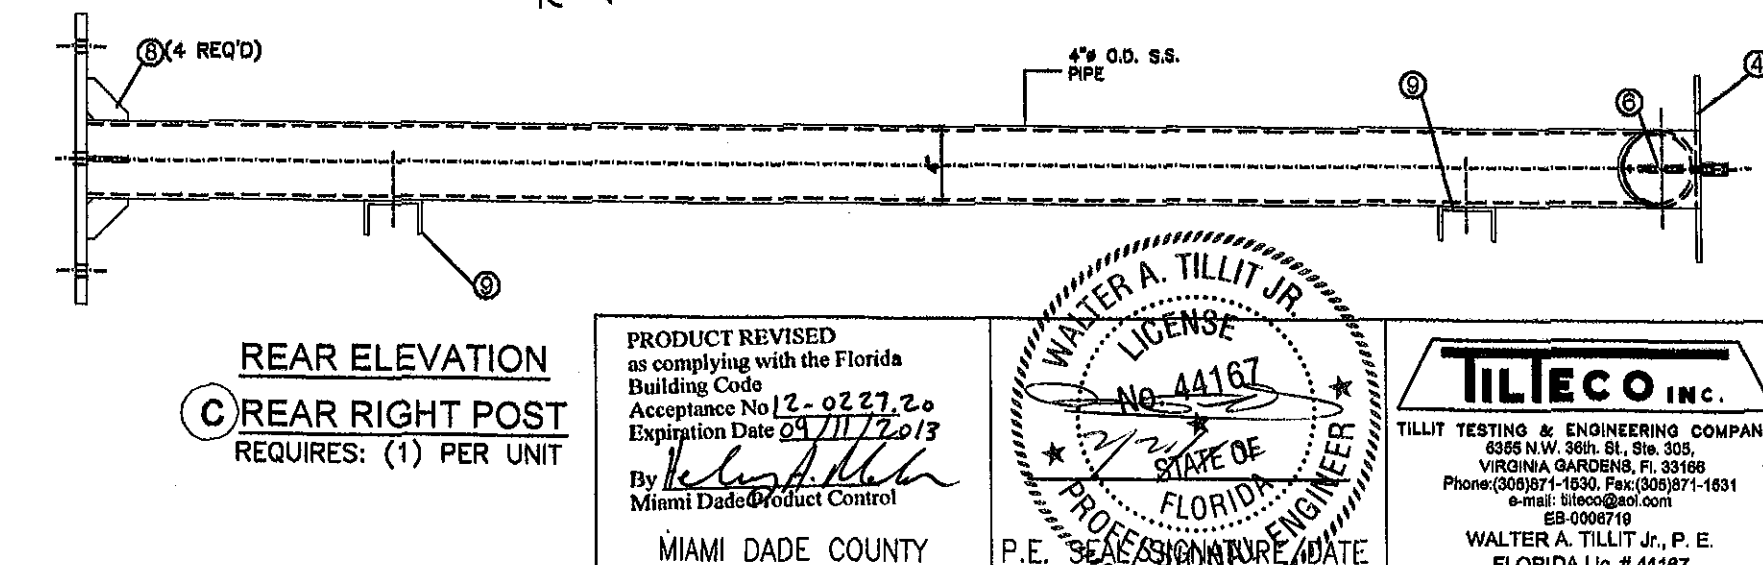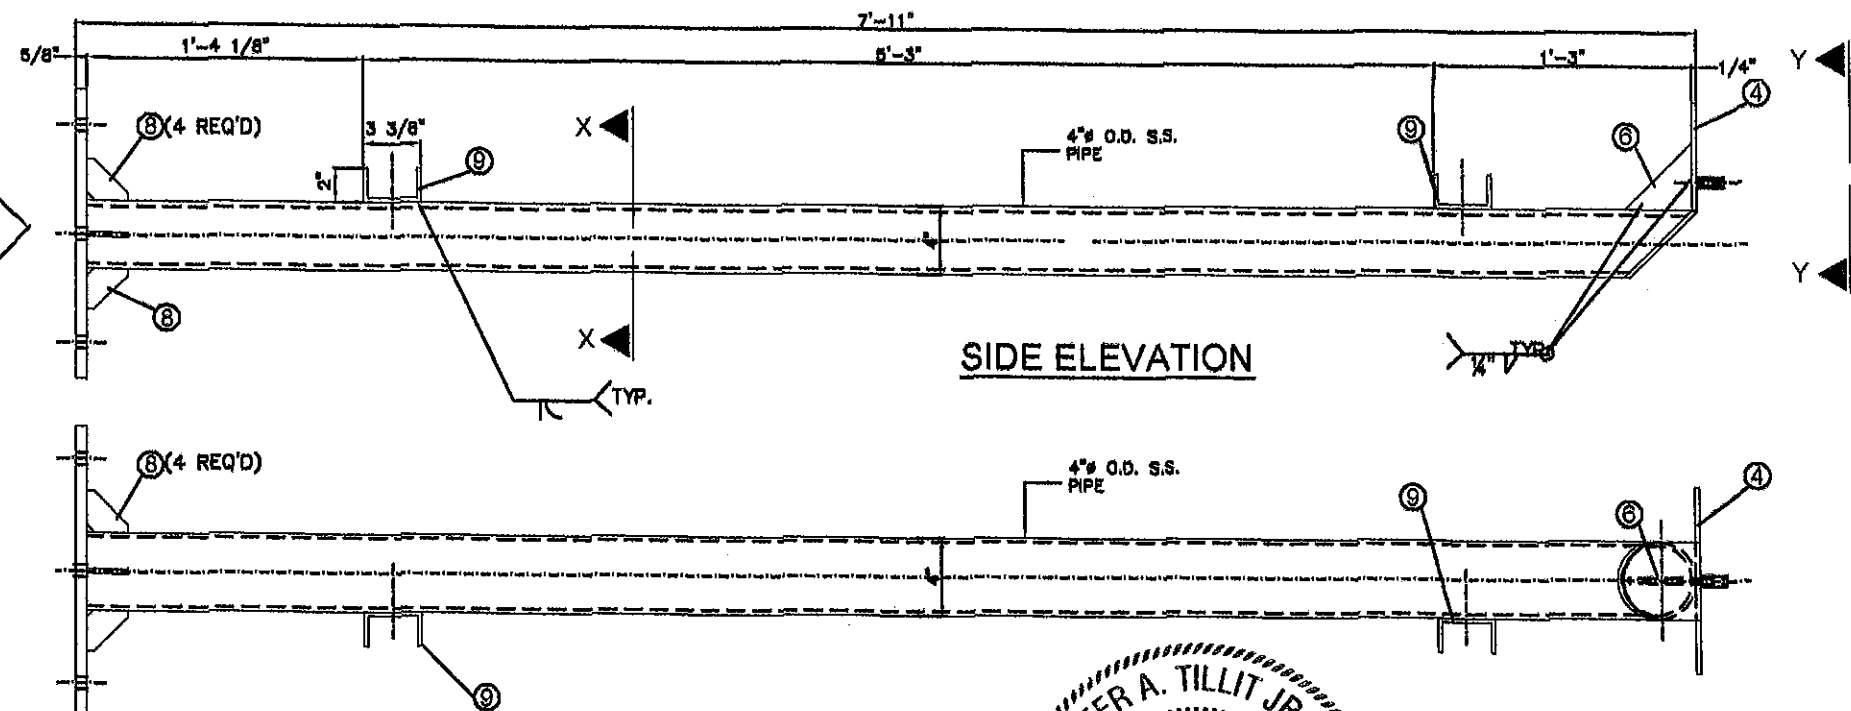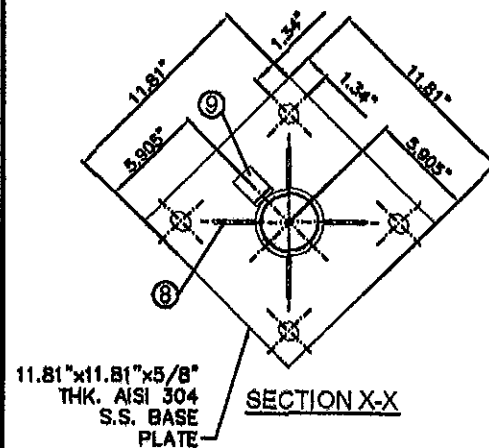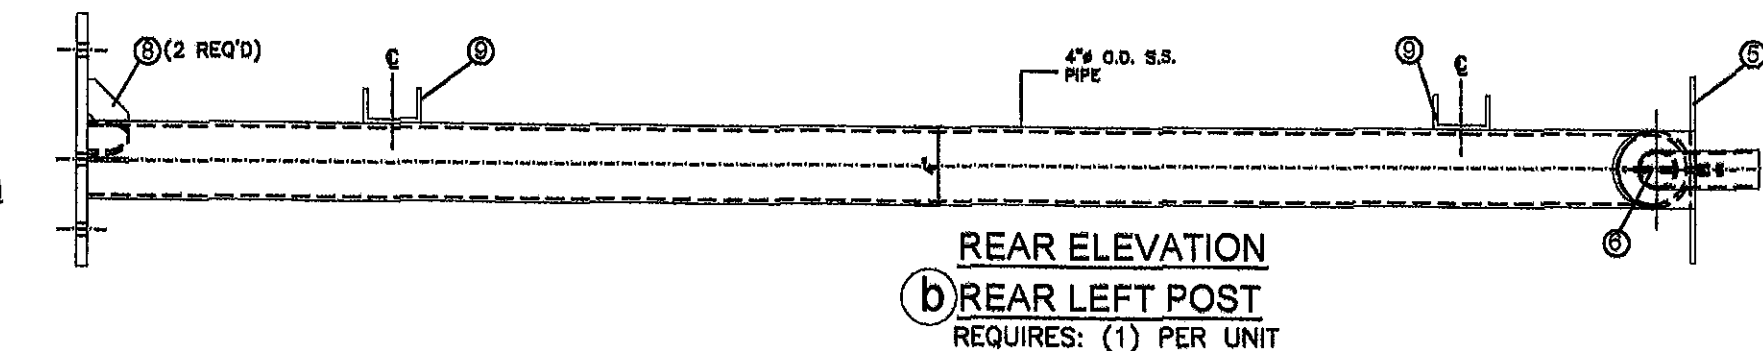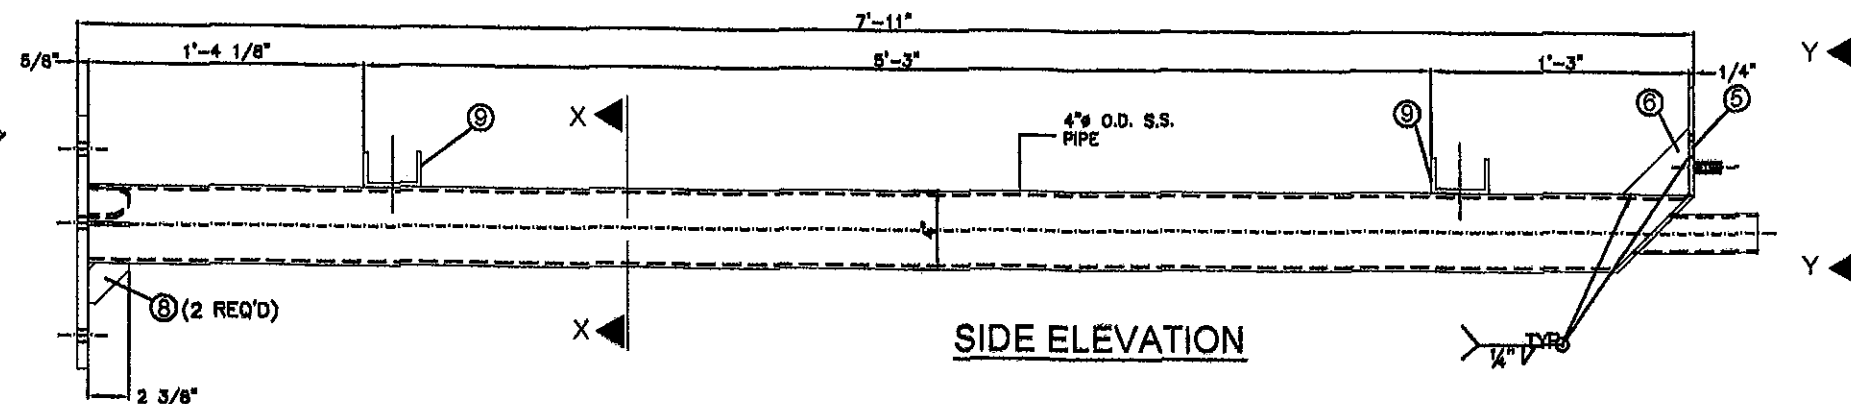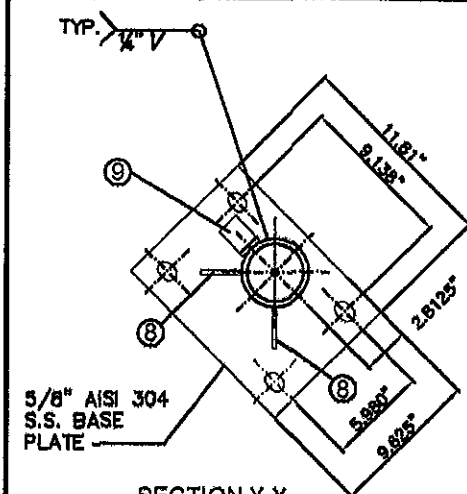

PRODUCT REVISED  
as complying with the Florida  
Building Code  
Acceptance No. 12-0227.20  
Expiration Date 09/11/2013  
By *Walter A. Tillit Jr.*  
Miami Dade Product Control  
MIAMI DADE COUNTY


WALTER A. TILLIT JR.  
LICENSE  
No. 44167  
2/2/13  
STATE OF  
FLORIDA  
PROFESSIONAL ENGINEER  
P.E. SEAL SIGNATURE/DATE

**TILTECO INC.**  
TILLIT TESTING & ENGINEERING COMPANY  
6365 N.W. 36th St., Ste. 305  
VIRGINIA GARDENS, FL 33166  
Phone: (305) 871-1530, Fax: (305) 871-1531  
e-mail: tillitco@aol.com  
ES-0006719  
WALTER A. TILLIT Jr., P. E.  
FLORIDA Lic. # 44167


MIAMI BUS  
SHELTER  
SLIM VERSION  
W/O OPPI PAL-LI  
SOLAR DISPLAY  
PANEL  
POST ELEVATIONS

MIAMI-DADE COUNTY TRANSIT  
DEPARTMENT  
701 NW 1ST COURT, SUITE 1700  
MIAMI, FLORIDA 33138-3822


DRAWN BY:  
M.C.V./A.G.  
02/10/12  
DATE:  
12-033  
DRAWING No.  
SHEET 7 OF 15

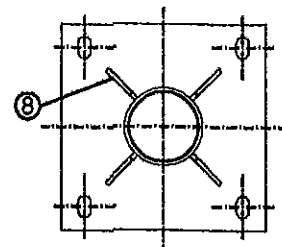


SECTION X-X

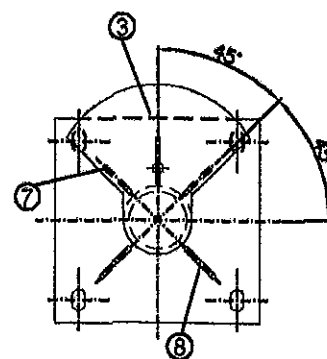


VIEW Y-Y

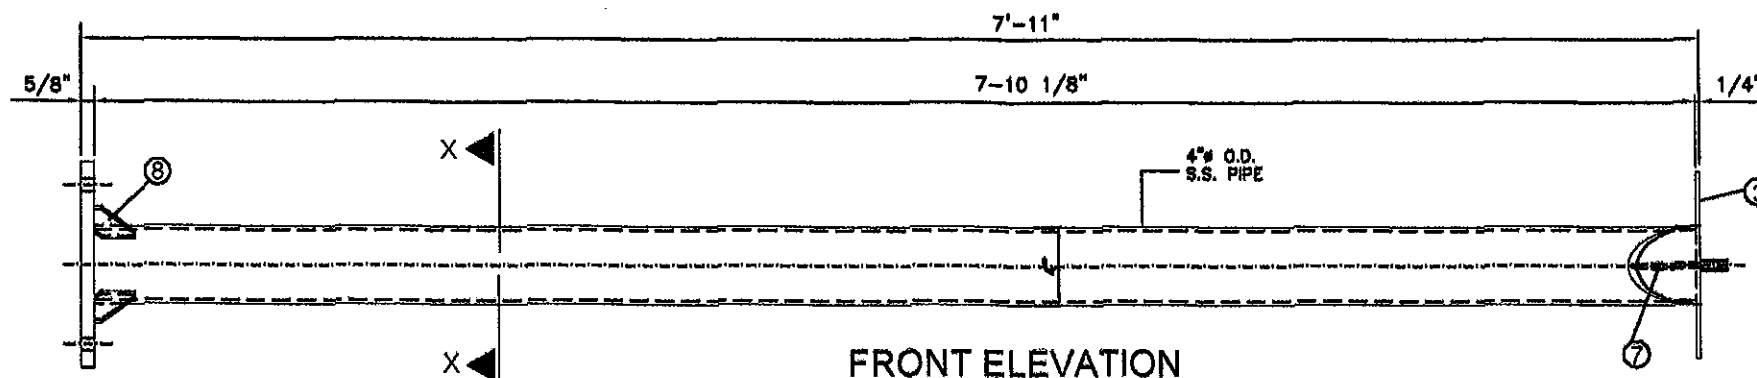


FRONT ELEVATION

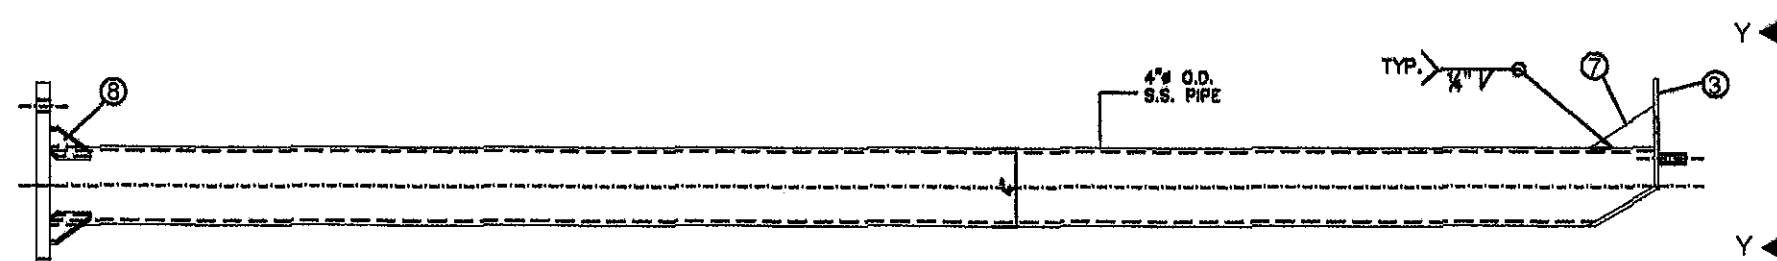

SIDE ELEVATION

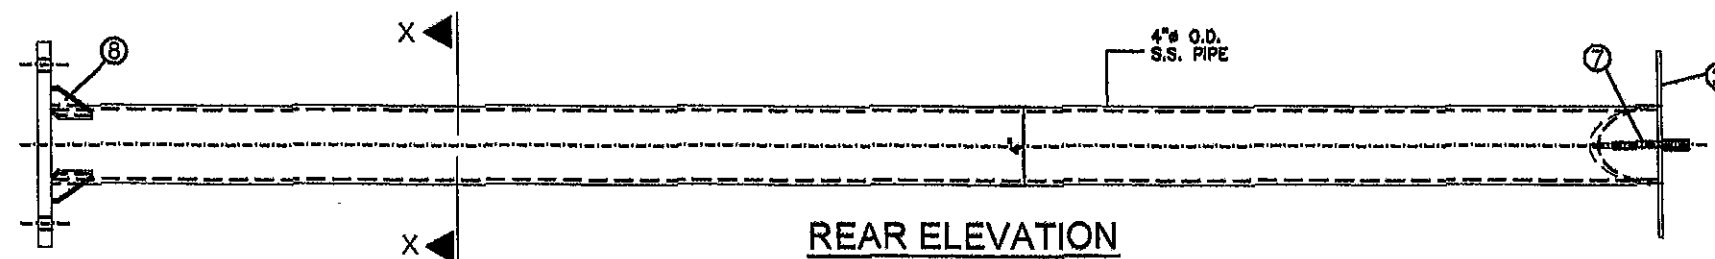

REAR ELEVATION

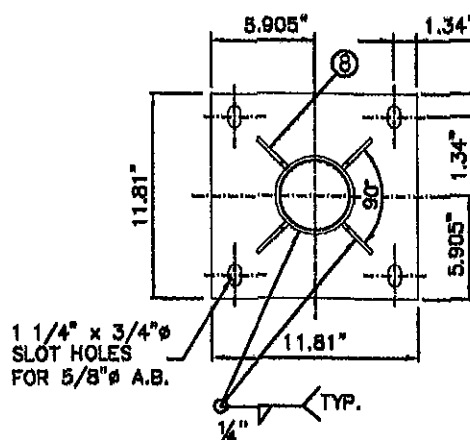


BASE PLATE

d FRONT POST

SCALE: 1/16" = 1'-0"  
REQUIRES: (2) PER UNIT

PRODUCT REVISED  
as complying with the Florida  
Building Code  
Acceptance No 12-0227.20  
Expiration Date 09/11/2013  
By *Walter A. Tillit Jr.*  
Miami Dade Product Control

MIAMI DADE COUNTY

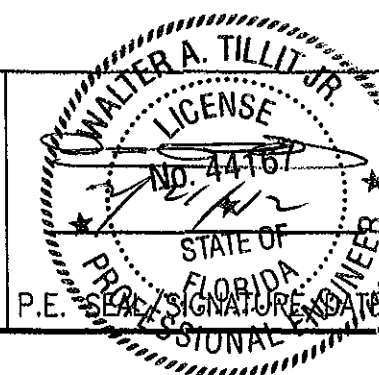

**TILTECO INC.**  
TILLIT TESTING & ENGINEERING COMPANY  
6355 N.W. 36th St., Ste. 305,  
VIRGINIA GARDENS, FL 33186  
Phone: (305) 871-1630, Fax: (305) 871-1631  
e-mail: tilteco@aol.com  
EB-0006719  
WALTER A. TILLIT Jr., P. E.  
FLORIDA Lic. # 44167

MIAMI BUS  
SHELTER  
SLIM VERSION  
W/O OPPI PAL-LI  
SOLAR DISPLAY  
PANEL

MIAMI-DADE COUNTY TRANSIT  
DEPARTMENT  
701 NW 1ST COURT, SUITE 1700  
MIAMI, FLORIDA 33138-3922


DRAWN BY:  
M.C.V./A.G.


02/10/12

DATE:

12-033  
DRAWING No.


SHEET 8 OF 15

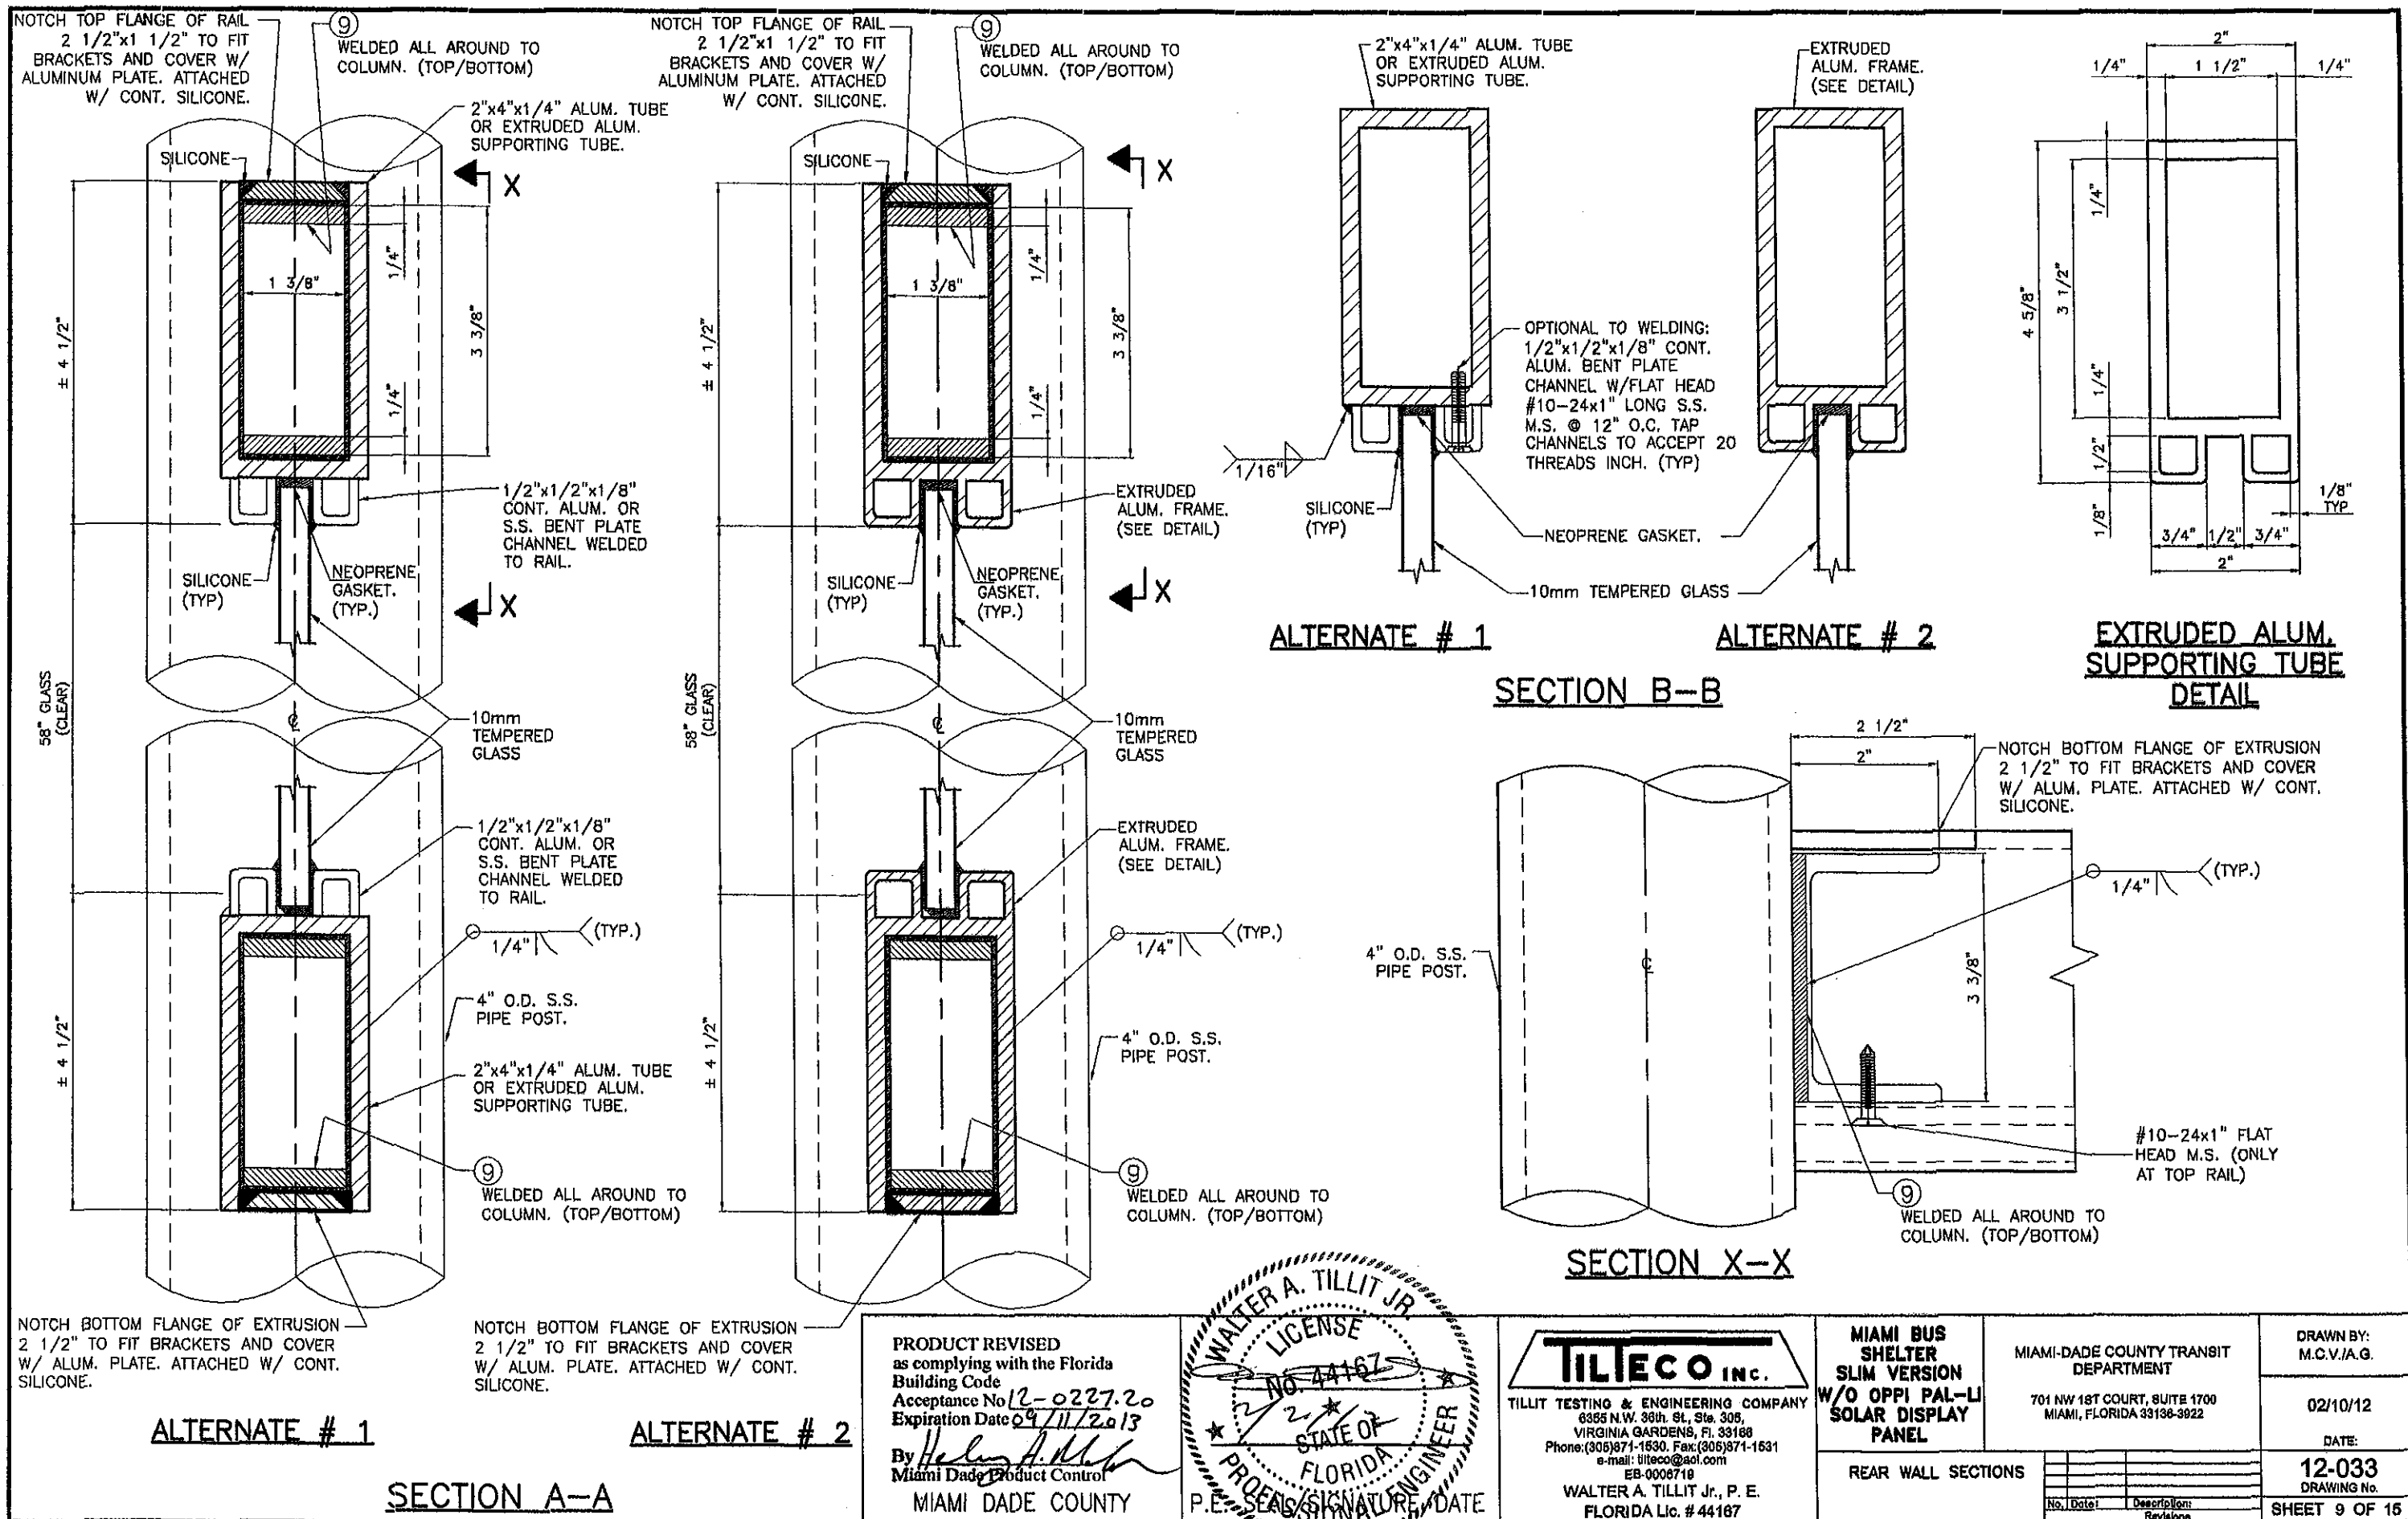

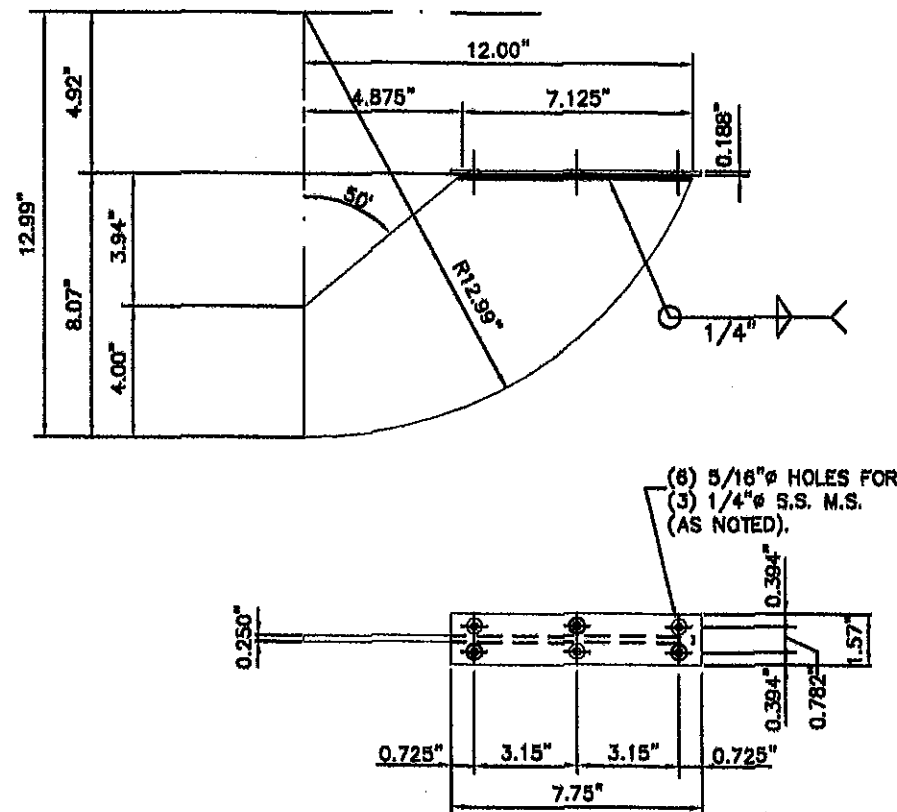

### 13 BENCH SUPPORT BRACKET


MATERIAL: 5052-H32 or 6063-T6  
ALUM. ALLOY WELDED PLATES  
REQUIRES: (3) PER UNIT

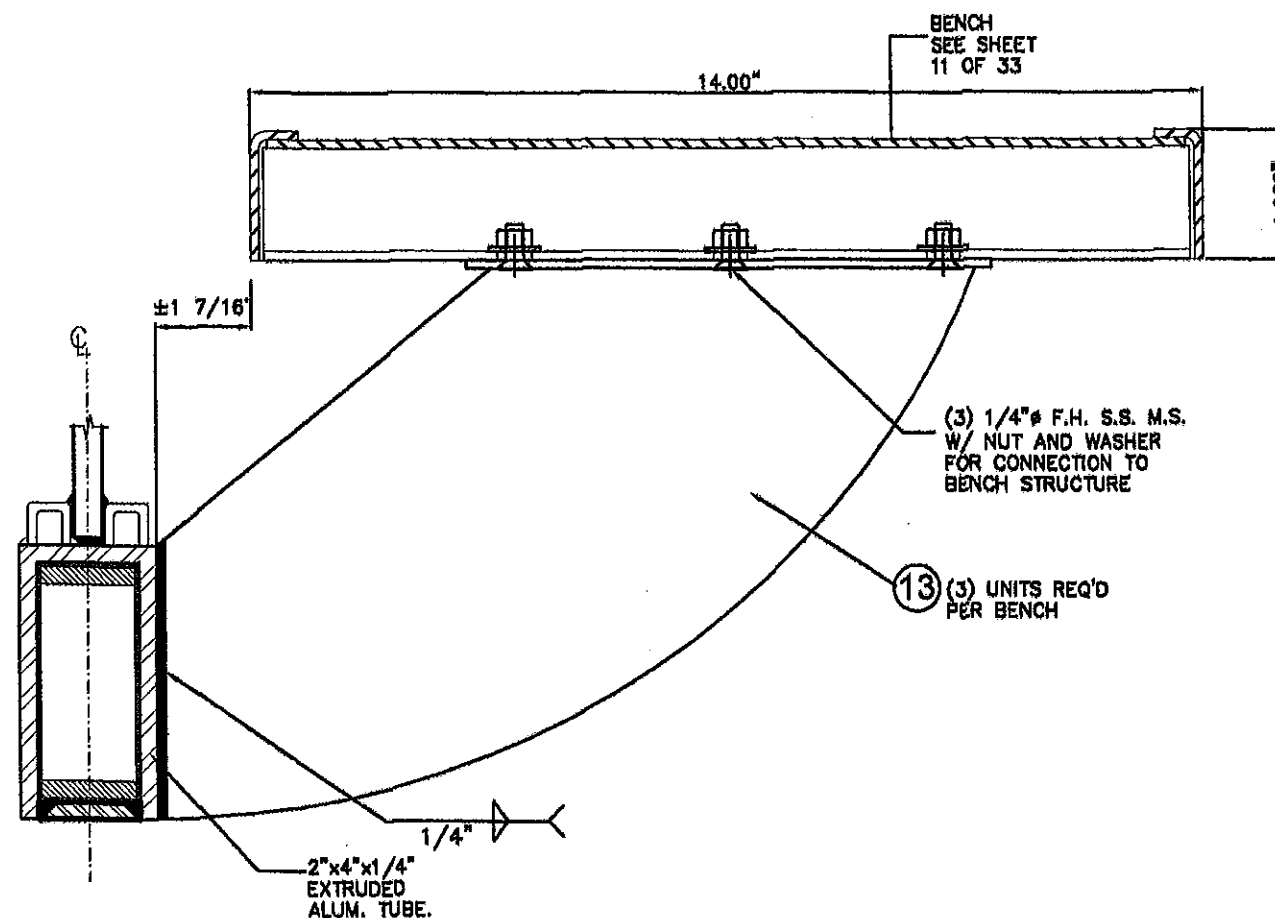

### ASSEMBLY BENCH TO BOTTOM RAIL SECTION

PRODUCT REVISED  
as complying with the Florida  
Building Code  
Acceptance No 12-022720  
Expiration Date 09/11/2013  
By *Walter A. Tillit Jr.*  
Miami Dade Product Control

MIAMI DADE COUNTY

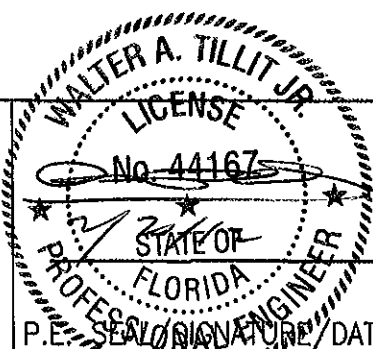

**TILTECO INC.**  
TILLIT TESTING & ENGINEERING COMPANY  
6355 N.W. 36th St., Ste. 305,  
VIRGINIA GARDENS, FL 33168  
Phone: (305) 871-1530, Fax: (305) 871-1531  
e-mail: tilteco@aol.com  
EB-0006719  
WALTER A. TILLIT Jr., P. E.  
FLORIDA Lic. # 44167

MIAMI BUS  
SHELTER  
SLIM VERSION  
W/O OPPI PAL-LI  
SOLAR DISPLAY  
PANEL

BEAM SUPPORT  
COMPONENTS

MIAMI-DADE COUNTY TRANSIT  
DEPARTMENT  
701 NW 1ST COURT, SUITE 1700  
MIAMI, FLORIDA 33136-3622

No. Date: Description: Revisions


DRAWN BY:  
M.C.V./A.G.

02/10/12

DATE:


12-033  
DRAWING No.

SHEET 10 OF 15

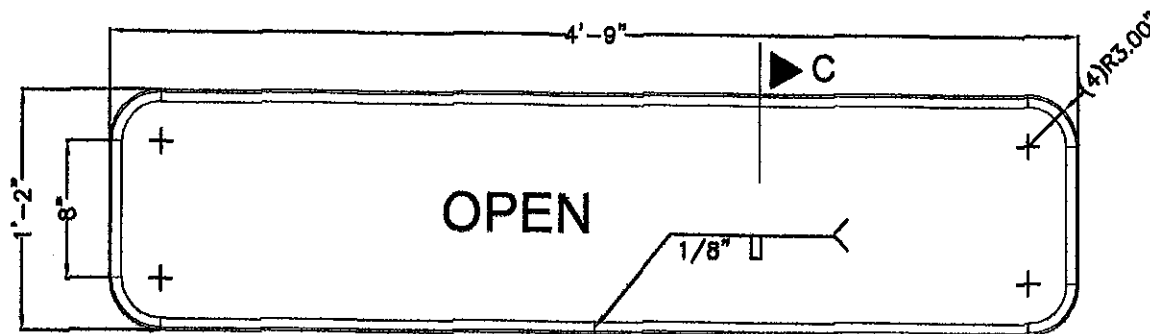


**OUTER RAIL(PROTO-MBENCH-103)**

0.125" THICK HOT ROLLED STEEL COIL ASTM A 1011  
NTS.

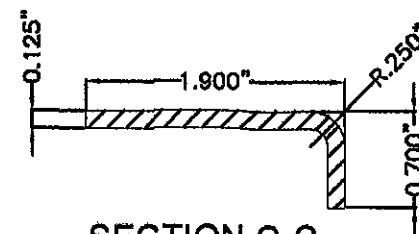


**SECTION C-C  
(TYP)**  
NTS.

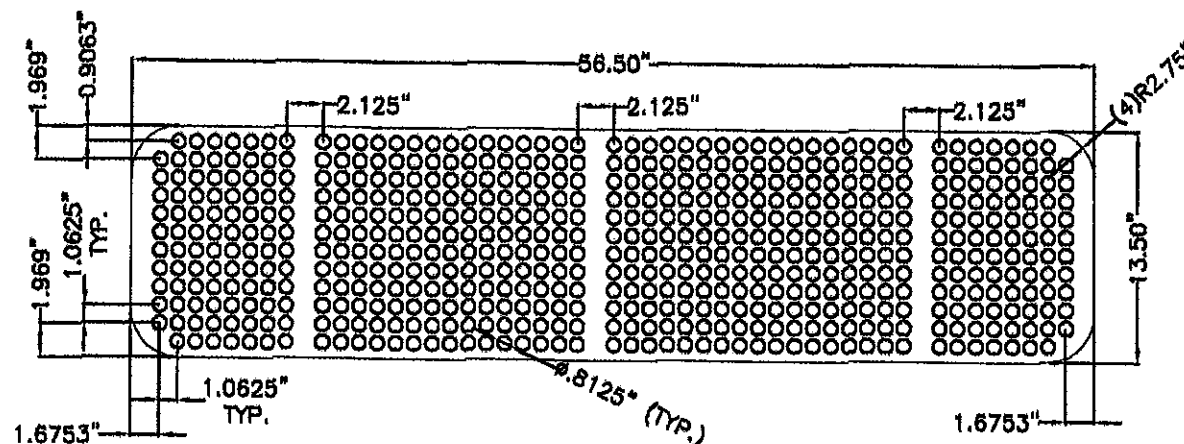

**THOMAS PERF. PIECE(PROTO-MBENCH-101B)**

0.135" THICK HOT ROLLED STEEL ASTM A-1011 CS, TYPE B  
NTS.

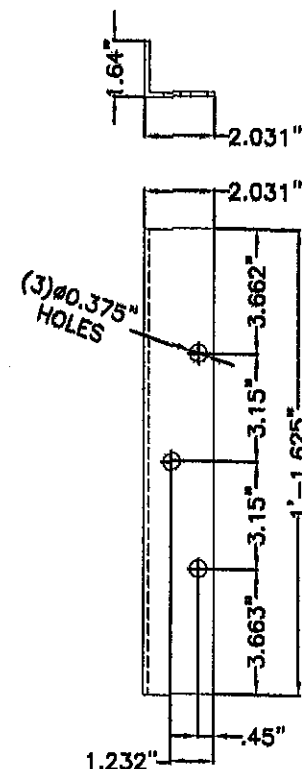


**BENCH SUPPORT  
(PROTO-MBENCH-102)**


CUT OF 0.135" THICK HOT ROLLED  
STEEL SHEET ASTM A 1011  
(3 UNITS PER BENCH REQ'D.)

NOTE: PUNCH HOLES, AND BEND.


NTS.

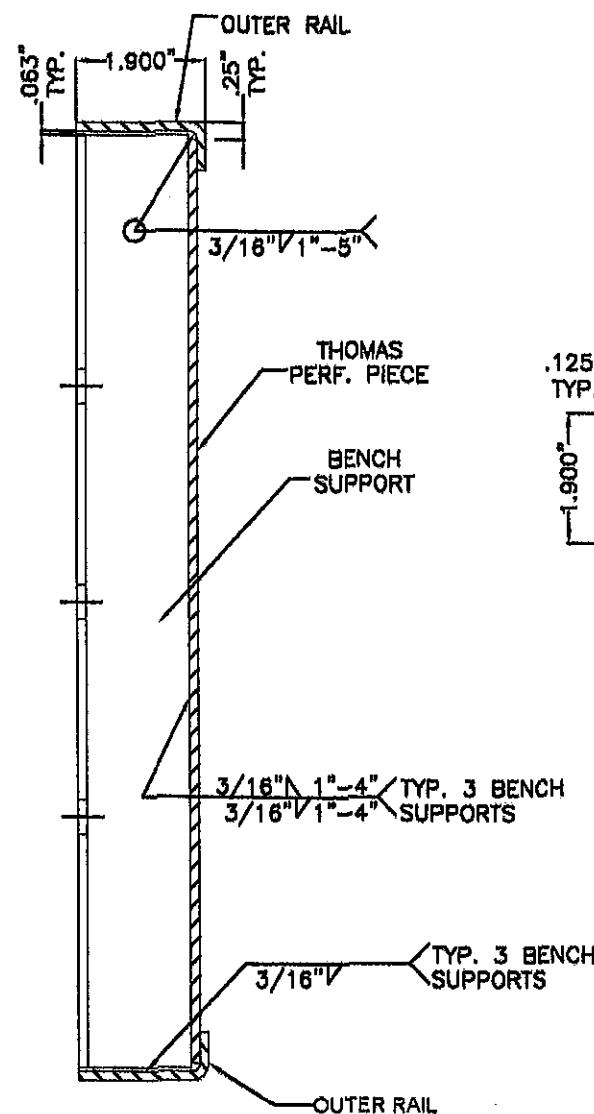

**SECTION A-A**  
NTS.

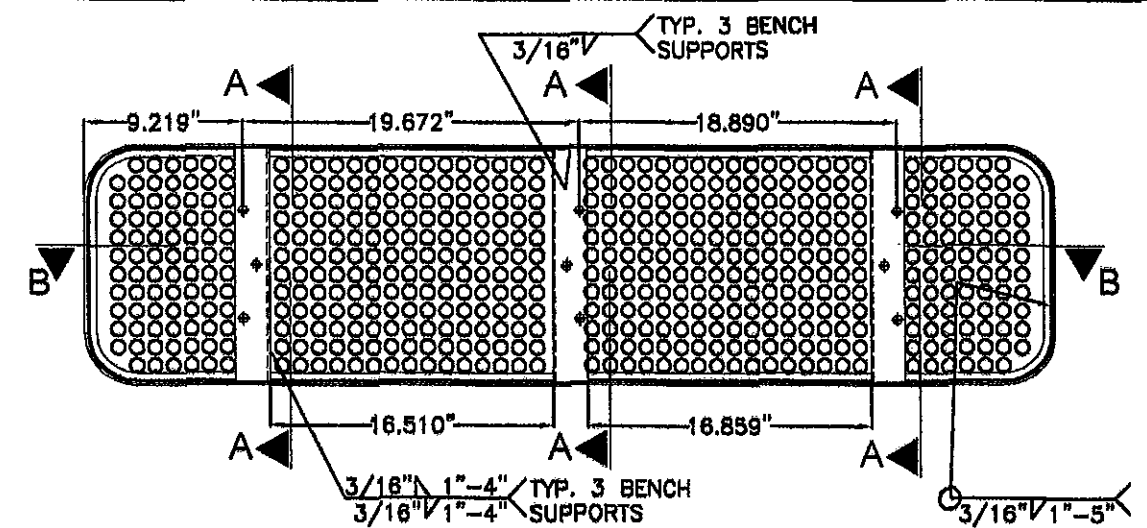

**BENCH ASSEMBLY**  
NTS.

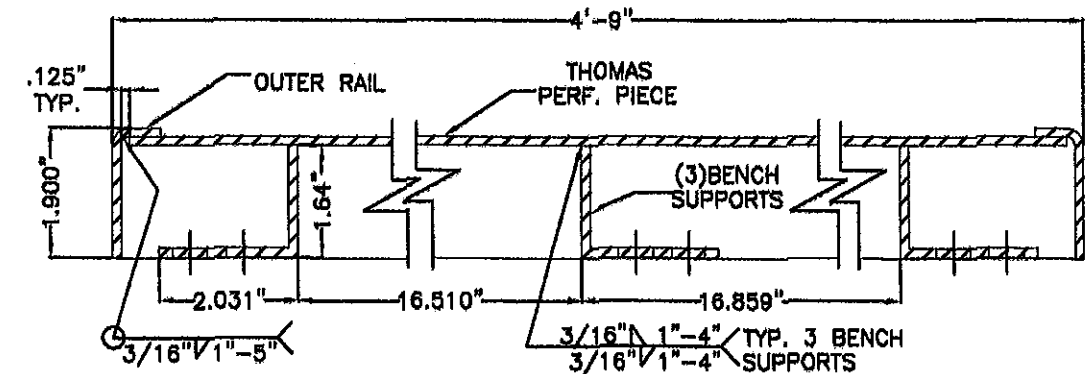

**SECTION B-B**  
NTS.

PRODUCT REVISED  
as complying with the Florida  
Building Code  
Acceptance No 12-0227.20  
Expiration Date 09/11/2013  
By *Walter A. Tillit Jr.*  
Miami Dade Product Control

MIAMI DADE COUNTY

WALTER A. TILLIT JR.  
LICENSE  
NO. 44167  
STATE OF  
FLORIDA  
P.E. SIGNATURE  
DATE

**TILTECO INC.**  
TILLIT TESTING & ENGINEERING COMPANY  
8355 N.W. 38th St., Ste. 305,  
VIRGINIA GARDENS, FL 33168  
Phone: (305) 871-1530, Fax: (305) 871-1531  
e-mail: tiltco@aol.com  
EB-0008719  
WALTER A. TILLIT Jr., P. E.  
FLORIDA Lic. # 44167

**MIAMI BUS  
SHELTER  
SLIM VERSION  
W/O OPPI PAL-LI  
SOLAR DISPLAY  
PANEL**

PROTO-M BENCH-0  
DETAILS

MIAMI-DADE COUNTY TRANSIT  
DEPARTMENT  
701 NW 18T COURT, SUITE 1700  
MIAMI, FLORIDA 33138-3922


DRAWN BY:  
M.C.V./A.G.

02/10/12

DATE:


**12-033**  
DRAWING No.

SHEET 11 OF 15

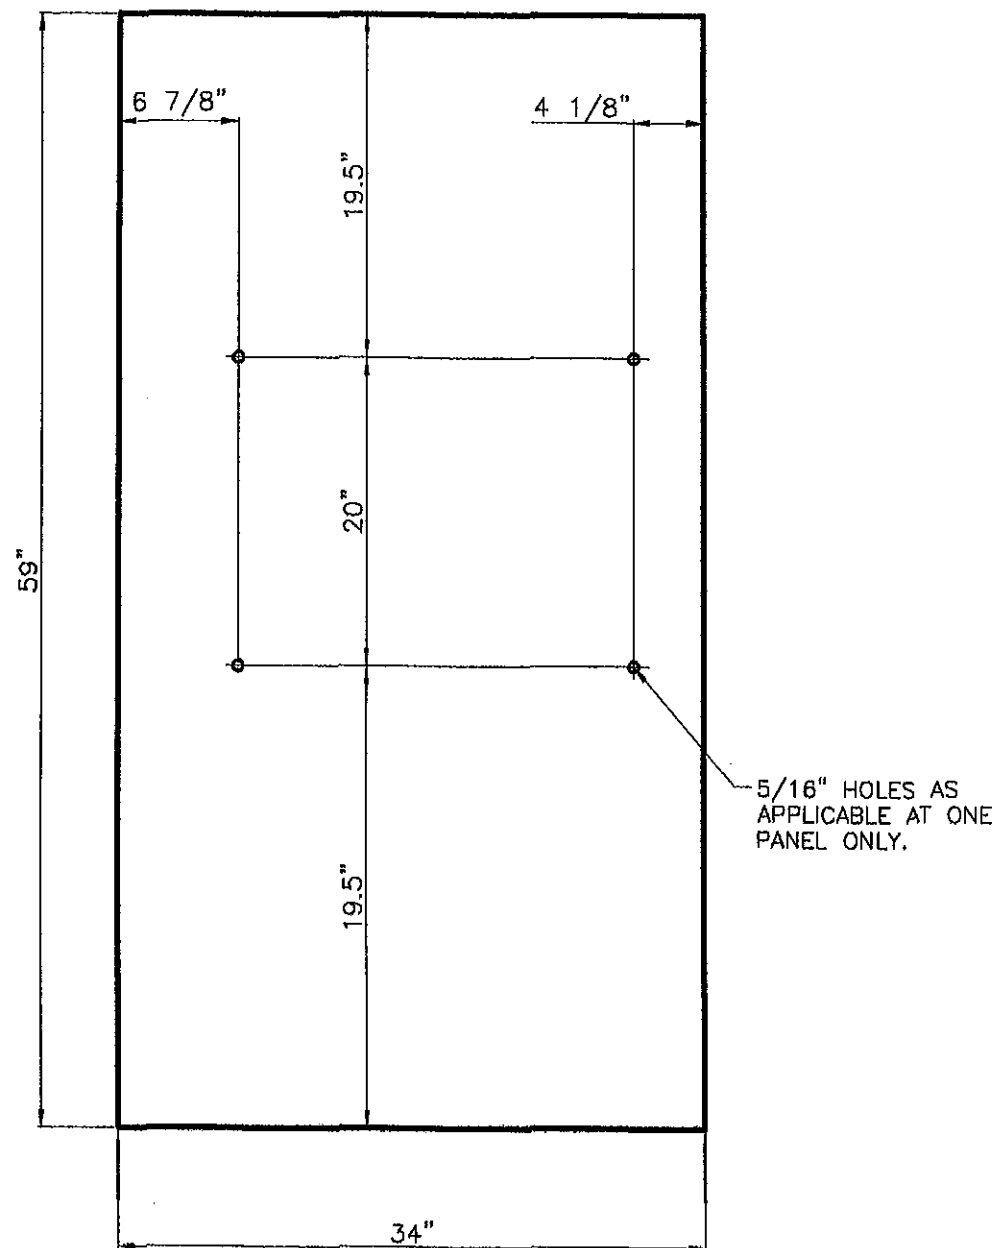

# **REAR WALL GLASS – BUS SHELTER**


N.T.S.  
10mm TEMPERED GLASS W/ GROUND EDGES  
REQUIRES:(4) PER UNIT

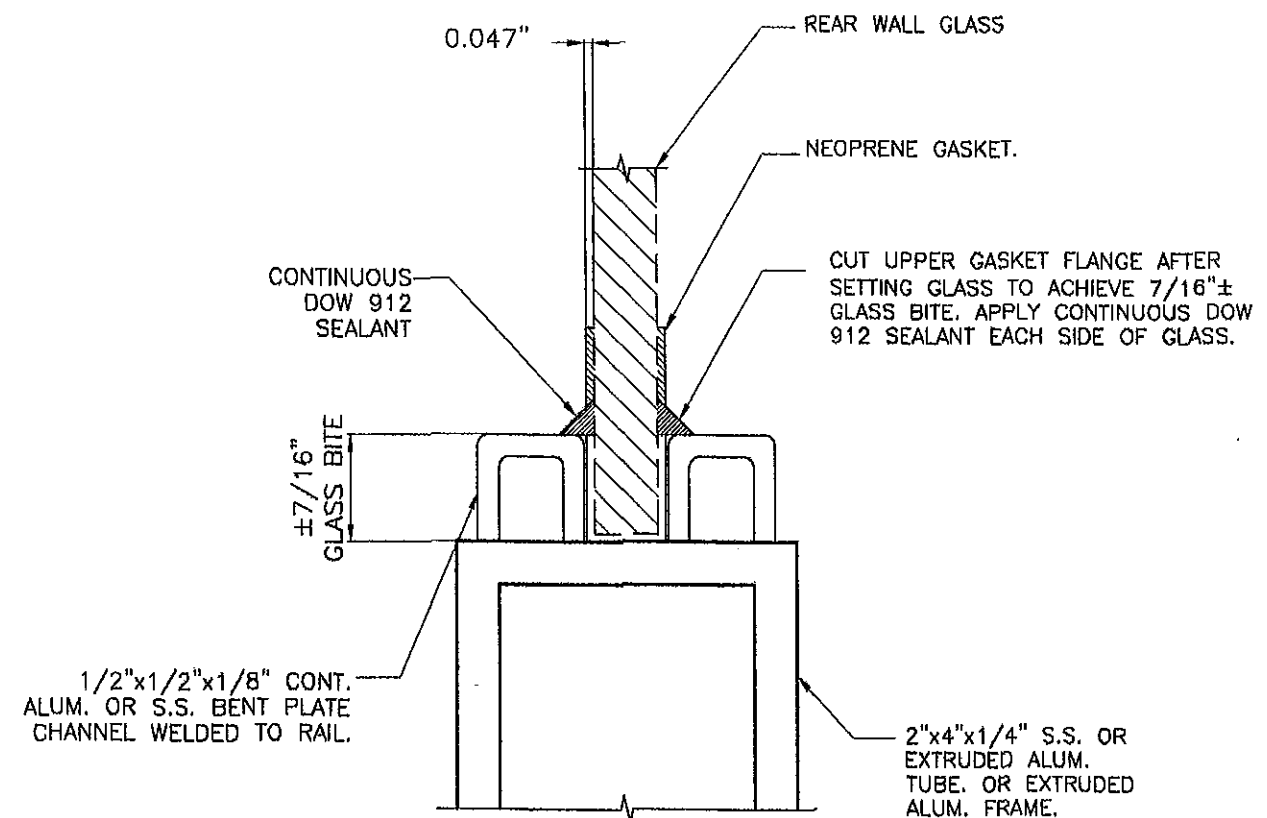

## **RUBBER GASKET-UPPER & LOWER GLASS EDGE: GLAZING DETAIL**

N.T.S.  
MATERIAL: NEOPRENE RUBBER  
REQUIRES:(24') PER UNIT  
THICKNESS: 10mm

PRODUCT REVISED  
as complying with the Florida  
Building Code  
Acceptance No 12-0227.20  
Expiration Date 09/11/2013  
By *Walter A. Tillit Jr.*  
Miami Dade Product Control  
MIAMI DADE COUNTY

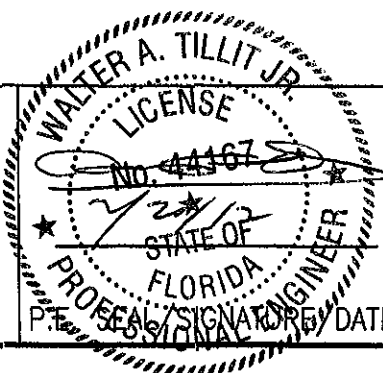

**TILTECO inc.**  
TILLIT TESTING & ENGINEERING COMPANY  
6355 N.W. 38th St, Ste. 305,  
VIRGINIA GARDENS, FL 33186  
Phone:(305)871-1630. Fax:(305)871-1631  
e-mail: tilliteco@aol.com  
EB-0006719  
WALTER A. TILLIT Jr., P. E.  
FLORIDA Lic. # 44167

**MIAMI BUS  
SHELTER  
SLIM VERSION  
W/O OPPI PAL-LI  
SOLAR DISPLAY  
PANEL**

MIAMI-DADE COUNTY TRANSIT  
DEPARTMENT  
701 NW 1ST COURT, SUITE 1700  
MIAMI, FLORIDA 33138-3922


DRAWN BY:  
M.C.V./A.G.

02/10/12

DATE:

**12-033**  
DRAWING No.


SHEET 12 OF 16

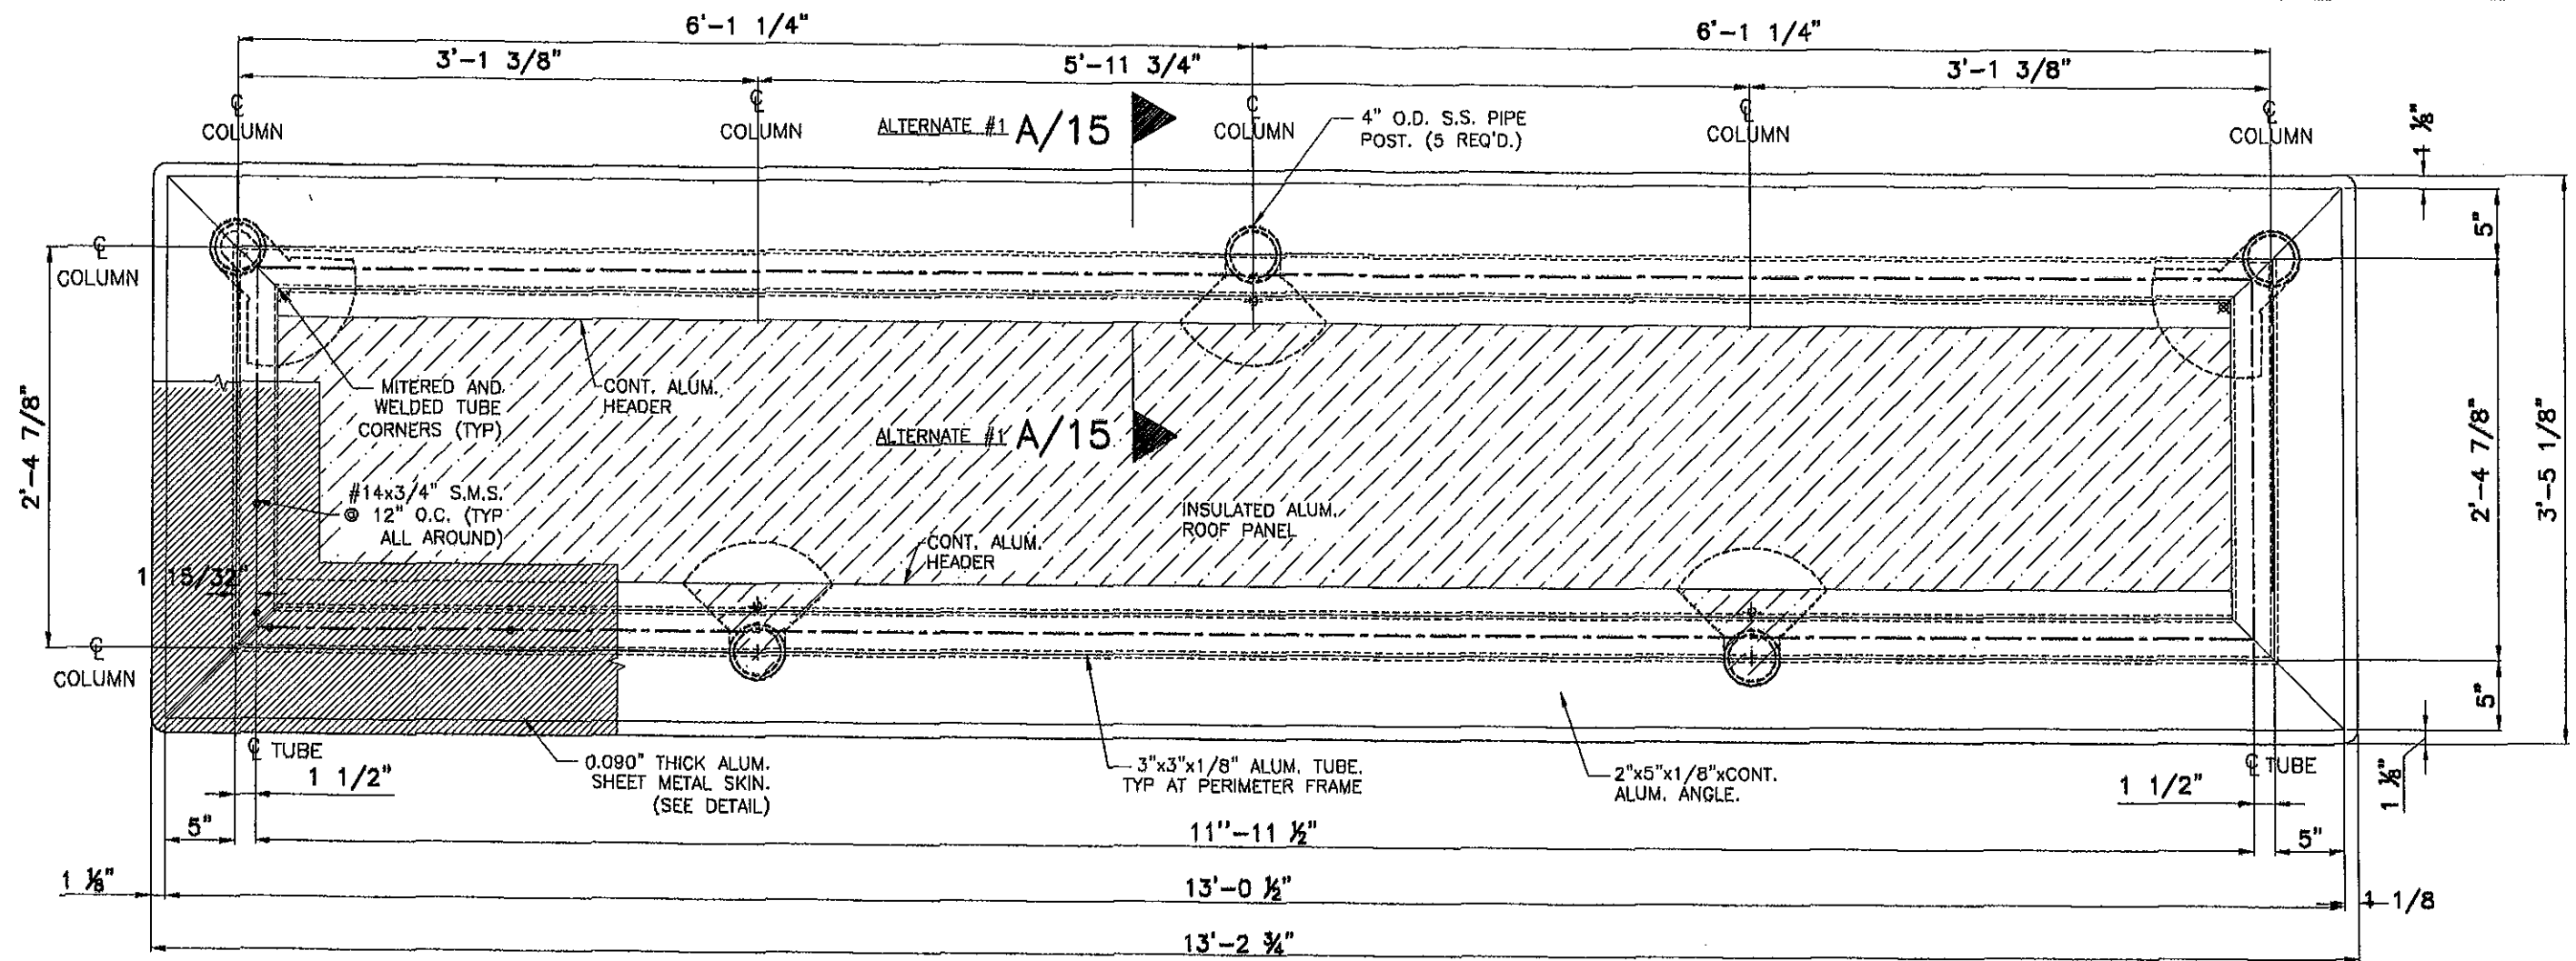

# ROOF STRUCTURE PLAN


ALTERNATE #1

SCALE: 1"=1'-0"

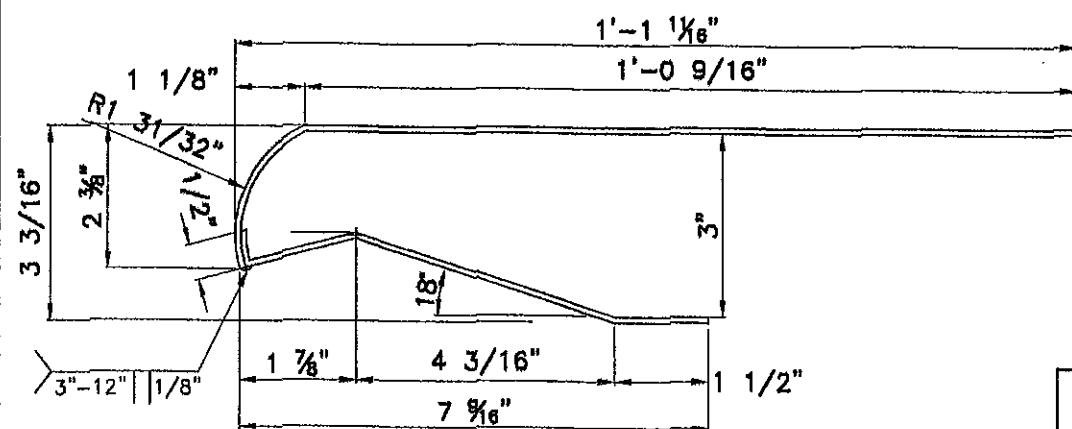

0.090" THICK ALUM.  
SHEET METAL SKIN.  
(DETAIL)  
N.T.S.

PRODUCT REVISED  
as complying with the Florida  
Building Code  
Acceptance No 12-0227-20  
Expiration Date 09/11/2013  
By *Walter A. Tillit Jr.*  
Miami Dade Product Control  
MIAMI DADE COUNTY

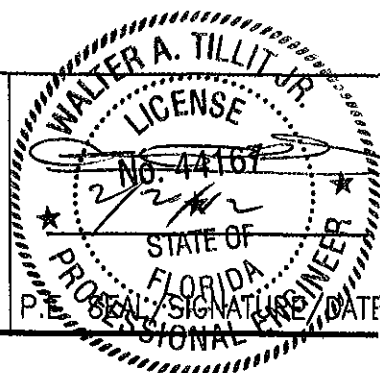

**TILTECO INC.**  
TILLIT TESTING & ENGINEERING COMPANY  
8355 N.W. 38th St., Ste. 305,  
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e-mail: tiltco@aol.com  
EB-0006719  
WALTER A. TILLIT Jr., P. E.  
FLORIDA Lic. # 44167

MIAMI BUS  
SHELTER  
SLIM VERSION  
W/O OPPI PAL-LI  
SOLAR DISPLAY  
PANEL

MIAMI-DADE COUNTY TRANSIT  
DEPARTMENT  
701 NW 1ST COURT, SUITE 1700  
MIAMI, FLORIDA 33136-3822

DRAWN BY:  
M.C.V./A.G.

02/10/12

DATE:


12-033  
DRAWING No.

ROOF STRUCTURE PLAN  
ALTERNATE #1


| No. | Date | Description | Revisits |
|-----|------|-------------|----------|
|     |      |             |          |
|     |      |             |          |
|     |      |             |          |

SHEET 13 OF 16



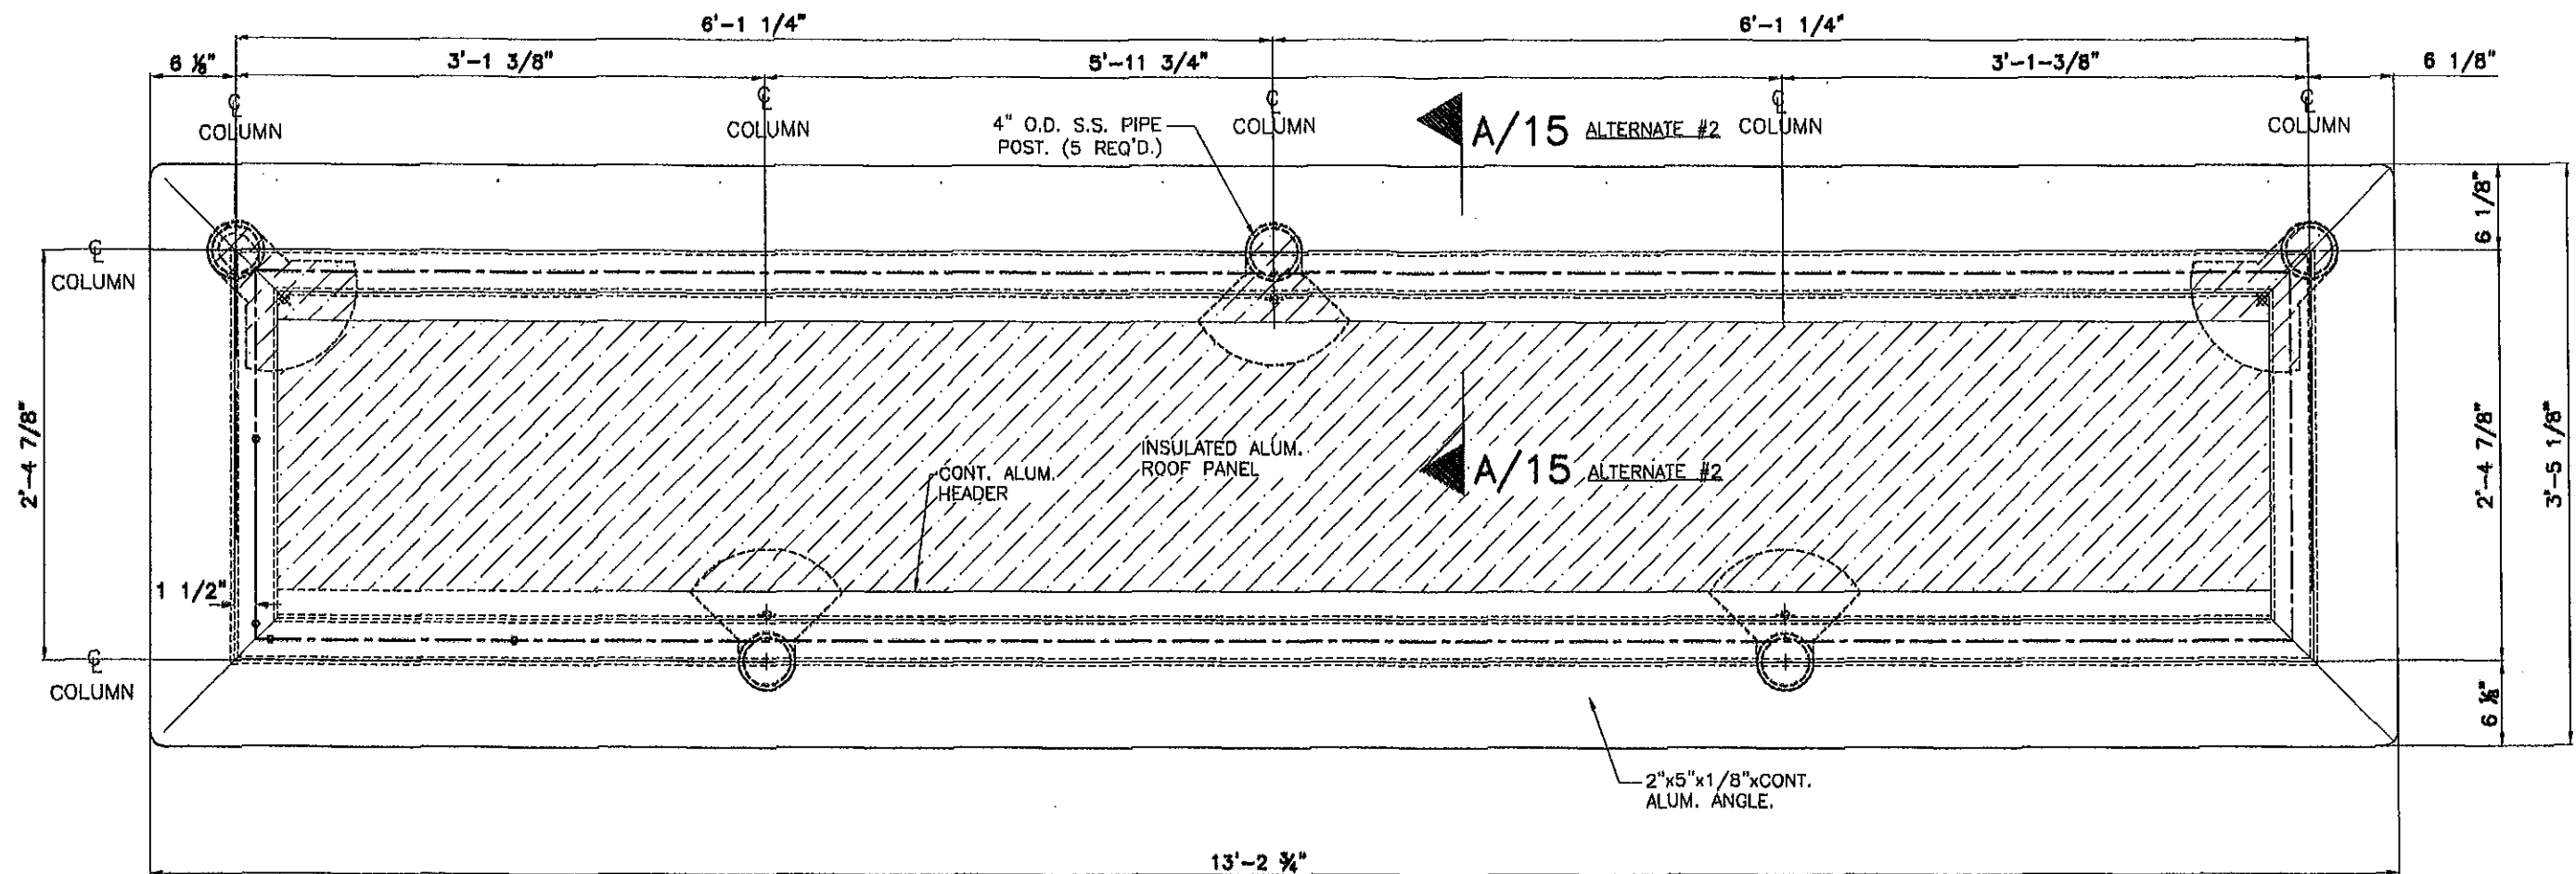


ROOF STRUCTURE PLAN  
ALTERNATE #2  
SCALE: 1"=1'-0"

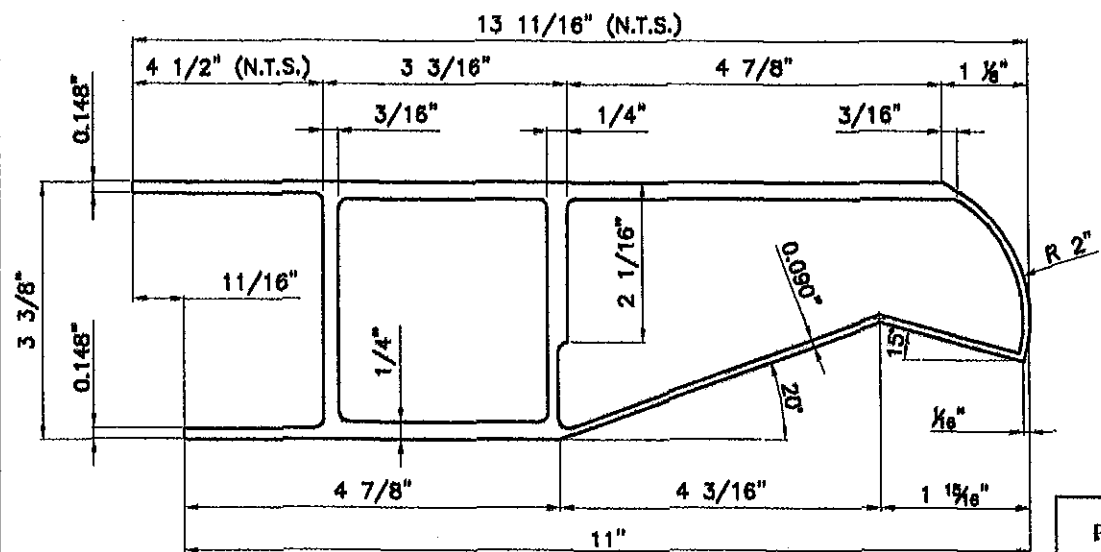

EXTRUDED ALUMINUM SUPPORTING  
ROOF FRAME DETAIL  
N.T.S.

PRODUCT REVISED  
as complying with the Florida  
Building Code  
Acceptance No 12-0227.20  
Expiration Date 09/11/2013  
By *Helmut A. Tillit*  
Miami Dade Product Control  
MIAMI DADE COUNTY

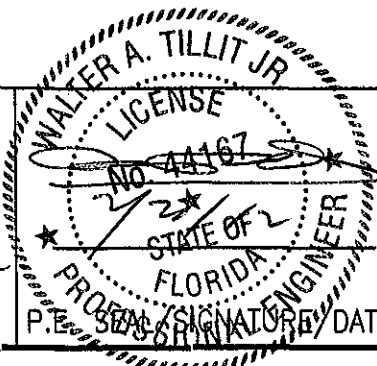

**TILTECO INC.**  
TILLIT TESTING & ENGINEERING COMPANY  
6355 N.W. 38th St., Ste. 305,  
VIRGINIA GARDENS, FL 33198  
Phone: (305) 871-1530. Fax: (305) 871-1531  
e-mail: tiltco@aol.com  
BB-0008719  
WALTER A. TILLIT Jr., P. E.  
FLORIDA Lic. # 44167

MIAMI BUS  
SHELTER  
SLIM VERSION  
W/O OPPI PAL-LI  
SOLAR DISPLAY  
PANEL

MIAMI-DADE COUNTY TRANSIT  
DEPARTMENT  
701 NW 1ST COURT, SUITE 1700  
MIAMI, FLORIDA 33136-3922

DRAWN BY:  
M.C.V./A.G.

02/10/12



DATE:

12-033  
DRAWING No.


ROOF STRUCTURE PLAN  
ALTERNATE #2

| No. | Date | Description |
|-----|------|-------------|
|     |      |             |
|     |      |             |

SHEET 14 OF 15

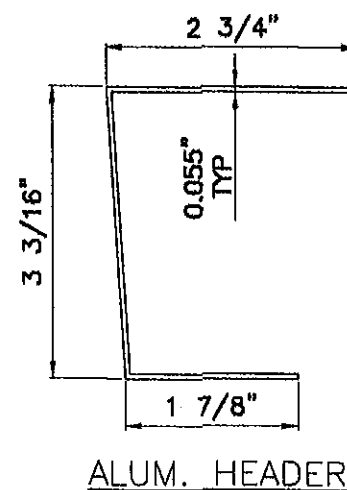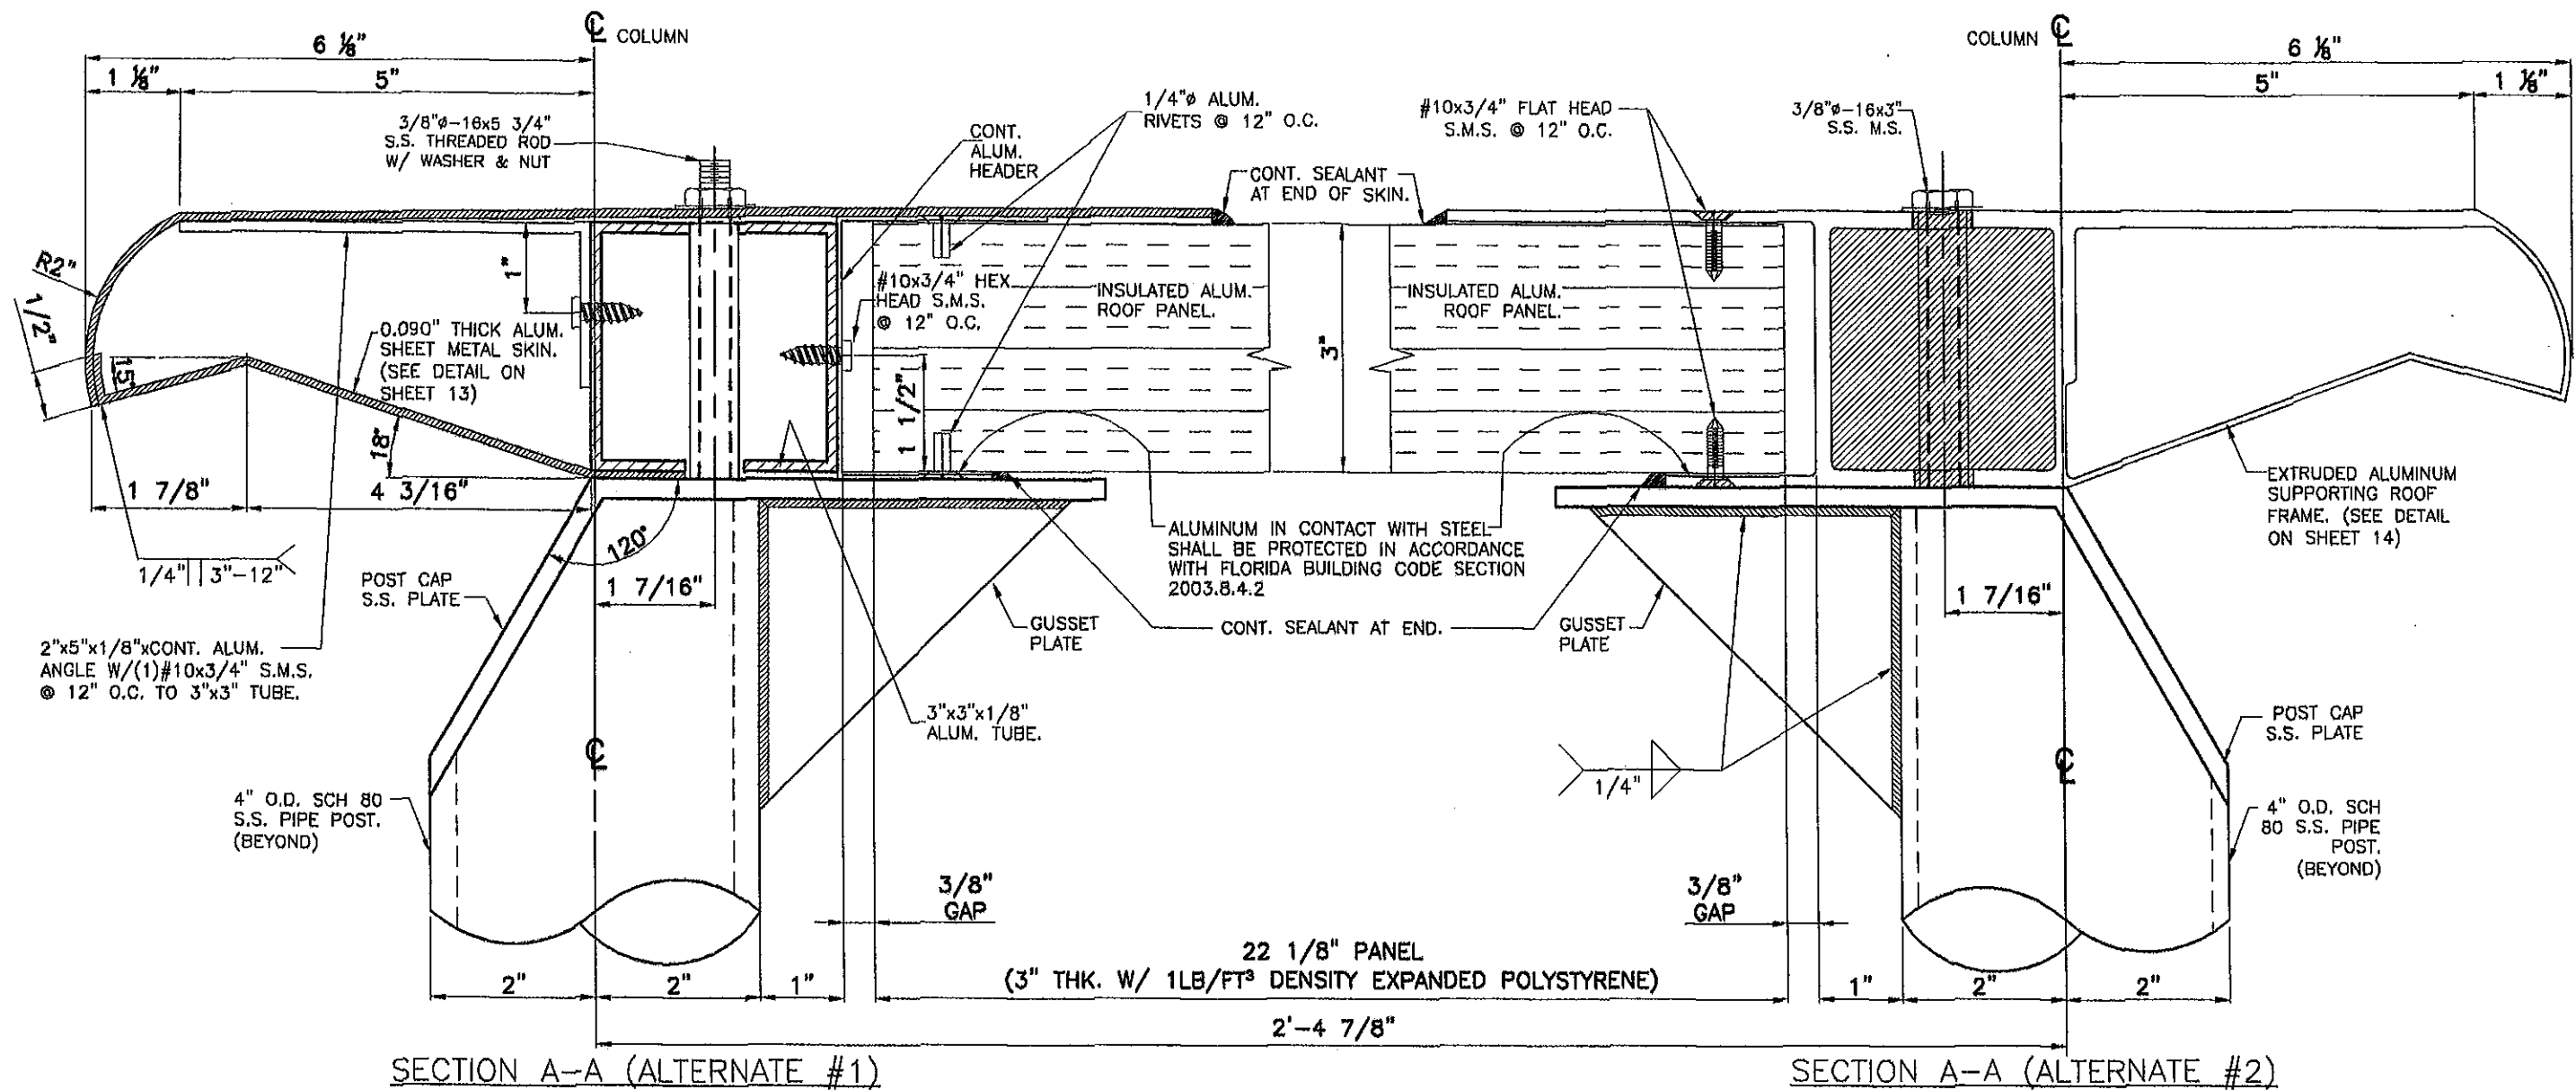

PRODUCT REVISED  
as complying with the Florida  
Building Code  
Acceptance No 12-0227.20  
Expiration Date 09/11/2013  
By *Walter A. Tillit Jr.*  
Miami Dade Product Control  
MIAMI DADE COUNTY

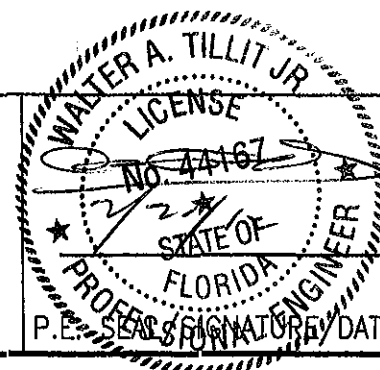

**TILTECO INC.**  
TILLIT TESTING & ENGINEERING COMPANY  
8366 N.W. 38th St., Ste. 305,  
VIRGINIA GARDENS, FL 33168  
Phone: (305) 871-1530, Fax: (305) 871-1531  
e-mail: tilteco@aol.com  
E8-0008710  
WALTER A. TILLIT Jr., P. E.  
FLORIDA Lic. # 44187

MIAMI BUS  
SHELTER  
SLIM VERSION  
W/O OPPI PAL-LI  
SOLAR DISPLAY  
PANEL  
ROOF ALTERNATE  
#1 & #2 SECTIONS

MIAMI-DADE COUNTY TRANSIT  
DEPARTMENT  
701 NW 1ST COURT, SUITE 1700  
MIAMI, FLORIDA 33138-3922

DRAWN BY:  
M.C.V./A.G.

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DATE:

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SHEET 15 OF 15